

## PLANTING NOTES

1.

All plant materials shall meet or exceed current American Standard for Nursery Stock (ANSI Z60.1-2004) and the Colorado Nursery Act and accompanying Rules and Regulations.
2.

All plants will be balled and burlapped or container grown. Bare root or spaded plants will not be accepted.
3.

Supply all plant material in quantities sufficient to complete the planting bed as shown on the drawings.
4.

All plants will be inspected and approved by the Owner's Representative prior to delivery to the site.
5.

Any proposed substitutions of plant species shall be approved by the Landscape Architect and University representative prior to delivery to the site.
6.

Obtain Landscape Architects approval of finish grading prior to the start of planting.
7.

Stake locations of all proposed trees and edges of new planting beds for approval by the Landscape Architect prior to the commencement of planting.
8.

Landscape Contractor shall be responsible for becoming aware of all underground utilities, pipes and structures. The Landscape Contractor shall be held responsible for contacting all utility companies for field location of underground utility lines prior to any excavation. Landscape Contractor shall take sole responsibility for any cost of utility repair due to damage caused by his operations.
9.

Do not willfully proceed with construction as designed when it is obvious that unknown obstructions and/or grade differences exist that may not have been known during design. Such conditions shall be immediately brought to the attention of the Landscape Architect. The Landscape Contractor shall assume full responsibility for all necessary revisions due to failure to give such notification.
10.

Landscape Contractor shall be responsible for any coordination with subcontractors as required to accomplish planting operations.
11.

See specifications for planting requirements, soil preparation testing, materials and execution. Arrange for visit of Landscape Architect for review and approval a minimum of 48 hours prior to installation.
12.

See details and specifications for staking method, plant pit dimensions and backfill requirements.
13.

Landscape Contractor shall provide per-unit costs for every size of plant materials, and by type, as called out on planting plans. Unit cost to include the plant material itself and installation, including all labor, amendments, fertilizers, etc., as detailed and specified for each size.
14.

Landscape Contractor is responsible to do their own quantity takeoffs for all plant materials and sizes shown on plans.
15.

The Landscape Contractor shall be responsible for positive drainage throughout the site with accurately set flow lines. No low spots or ponding of surface water will be accepted in final work.
16.

Coordinate installation of large plant material with installation of wall footings, bridge abutments and pavements. Any damage to improvements by others is the responsibility of the Landscape Contractor.
17.

The Landscape Contractor shall allow for the addition of specified quantities of soil amendments, conditioners and mulch in soil preparation and finish grading.
18.

Imported soil shall be used to supplement the existing soil as necessary to meet the finish grade requirements at planting areas.
19.

The Landscape Contractor shall verify soil test at his expense prior to planting and will follow test recommendations and Landscape Architect's approval for soil amendments.
20.

The Landscape Contractor shall receive the specified subgrade elevation, of +/- one tenth of a foot below finish grade. The Landscape Contractor shall be responsible to furnish and install amended or imported soil in any planting areas as necessary to achieve the specified finish planting grades unless otherwise noted on plans or specs.
21.

Contractor is to familiarize himself with the layout, grading and civil engineering documents to coordinate actual location of trees and shrubs.
22.

Maintenance Statement:  
All landscaping shown on this plan shall be maintained in a neat and adequate manner. Required maintenance activities shall include, but not limited to, mowing of lawns, trimming of hedges, adequate irrigation, replacement of dead, diseased or unsightly landscaping, removal of weeds from planted areas, and appropriate pruning of plant materials.
23.

Take all dimensions from back of curb, center line of trees, and centerline of light pole bases, unless otherwise noted.
24.

Take all dimensions perpendicular to any reference line, centerline, building face, or back of curb.
25.

Written dimensions supercede scaled dimensions. Do not scale drawings, if there is a question regarding dimension, contact Landscape Architect for verification.

## GENERAL NOTES

1.

All work shall be performed in accordance with plans approved by the University of Colorado Anschutz Medical Campus.
2.

Base information provided by Civil Engineer. Refer to survey, plat, roadway and utility drawings, and other available documents for property limits, existing conditions, and horizontal and vertical control.
3.

The limits of work occur at the right-of-way or as shown on plans.
4.

Verify existing site conditions including, walls, vegetation fences, utilities, property lines, limits of roadways, curbs and gutters, and other obstructions that may affect the progress of work.
5.

Locate utilities and maintain their location during all phases of work. Do not damage utility lines/structures. Notify Owner's Representative of any discrepancies before starting any work. Contractor shall be responsible for location of underground utilities or structures, whether or not shown or detailed and installed by any other contract. Restoration of utilities damaged by the Contractor shall be at the Contractor's expense.
6.

Thoroughly review the site conditions, drawings, and technical specifications prior to construction. Complete the work of this project in accordance with approved drawings.
7.

Anything mentioned in the technical specifications and not shown on the drawings, or shown on the drawings and not mentioned in the technical specifications shall be of like effect as if shown on or mentioned in both.
8.

Construction installation, materials, testing and inspection shall comply with applicable codes and ordinances.
9.

Take necessary steps to protect and maintain all finished work for the duration of the contract until final acceptance
10.

These drawings do not specify safety materials, equipment, methods or sequencing to protect persons and property. Direct and implement safety operations and procedures to protect the Owner, other Contractors, the Public, and others for the duration of the contract.
11.

Notes and details on specific drawings take precedence over general notes and typical details.
12.

Obtain necessary permits from all jurisdictions as required to construct the work of this project.
13.

The work of this contract will not be considered complete until all areas have been cleaned of all dirt and debris and all damaged items are repaired.
14.

Irrigation system to be designed. It is anticipated that irrigation system will be a modification of the existing system. Lawn areas to have pop up heads. Shrub areas to have subsurface irrigation (netafim or similar.)

## LAYOUT NOTES

1.

Verify existing site information including, but not limited to street grades, utilities, property lines, limits of roadways, curbs and gutters taken from the Civil Engineer's drawings.
2.

All work shall comply with applicable codes and ordinances.
3.

Take all dimensions from back of curb, face of wall or building, and centerline of trees unless otherwise noted.
4.

All dimensions called out as 'equal' are equidistant measurements.
5.

Written dimensions supercede scaled dimensions. Do not scale drawings, if there is a question regarding dimensions, contact Dig Studio for verification.
6.

All angles to match those noted on drawing and all lines of paving to be parallel unless otherwise noted. Maintain horizontal alignment of adjacent elements as noted on drawings.
7.

Reference to north refers to true north. Reference to scale is for full sized drawings only. Do not scale from drawings.
8.

Concrete slabs or footings shall be doweled into abutting walls, foundations and footings only where shown on the plans and details.
9.

Provide expansion joints in concrete paving a maximum distance of 50 feet apart and at all intersections, where new concrete abuts existing concrete paving, buildings, curbs and walls unless otherwise noted.
10.

Provide control joints evenly spaced between expansion joints as shown on drawings, except where special score joint pattern is specified.
11.

Sleeves and conduits shall be installed a minimum of 18 inches below finished grade and shall extend 12 inches beyond back of curbs, walls, and paving.
12.

Coordinate and field verify all sleeving locations for all utility, electrical, and irrigation prior to construction.

## SHEET INDEX

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LM-101	MATERIALS PLAN
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LS-203	SITE ENLARGEMENT
LS-501	SITE DETAILS
LS-502	SITE DETAILS
LS-503	SITE DETAILS
LP-101	PLANTING PLAN
LP-102	PLANT PALETTE
LP-501	PLANTING DETAILS

## GRADING NOTES

1.

Employ a licensed surveyor to establish all grade and work lines. Have Owners Representative review grade stakes prior to final grading.
2.

All proposed grades shall meet and blend with existing grades at project limits and at curbs sidewalks and roadways. Existing elevations indicated on plans shall be verified in field to as-built condition.
3.

Erosion Control- See Civil Engineering Drawings for Contractor responsibilities, means, and methods.
4.

Contractor shall be responsible for 'rounding off' all sharp ridges existing on site whether or not such conditions are indicated on plans. Round tops and toes of slope to provide smooth transition to existing grade. Berms and landforms will be smooth and rounded vertical curves with no sharp transition in grade, unless otherwise noted.
5.

Contractor shall not proceed with construction when it becomes evident that unforeseen obstructions, area discrepancies and/or grade differences exist. Such conditions shall be immediately brought to the attention of the Owner's Representative for decision. The Contractor shall assume full responsibility for all necessary revisions due to failure to give such notification.
6.

All landscape grades are based upon elevations shown on the Civil Engineer drawings.
7.

Contractor shall be responsible for any coordination with subcontractors as required to accomplish all grading operations.
8.

Maintain positive drainage, unless specifically designed for ponding, at all times. Minimum 2% slope in planted areas, Minimum 1% in paved areas. Refer to Civil Engineer's drawings for drainage structure locations and details..
9.

Hold finish grades of shrub and ground cover areas 1" below the top of adjacent pavements or curbs, unless otherwise noted.
10.

Subsurface drainage lines shall be placed with a minimum of 12" cover. Contractor is responsible for verifying invert elevations at all drains and pipe depths to ensure positive drainage at the slope indicated to the outlet shown on the plans.
11.

Maximum slope in landscape planting areas is 3:1. Max slope in turf/sod areas is 4:1.
12.

No change in contract price will be allowed for actual or claimed discrepancy between existing grade and those shown on plans after Contractor has accepted existing grades and moved onto site
13.

Maximum running slopes along walkways are designed and drawn at 4.8% slope in order to ensure the finished slope is below 5% per ADA guidelines. No running slopes in the direction of travel on paved surfaces are to be greater than 5% without a handrail.
14.

Maximum cross slope on walkways are designed and drawn at 1.8% slope in order to ensure the finished cross slope is less than 2% per ADA guidelines. No cross slopes on paved surfaces are to be greater than 2%.

### REVISIONS:

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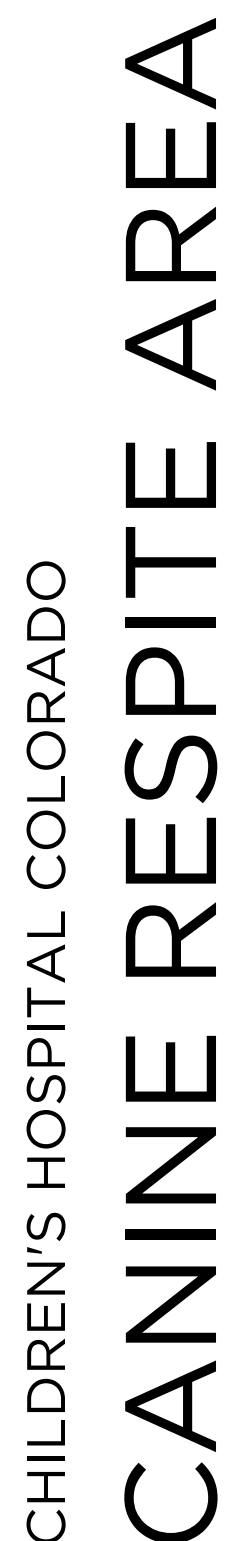
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SHEET TITLE  
GENERAL NOTES

SHEET NUMBER

LS-001





No.	DATE	DESCRIPTION	BY
	11-03-20	DD SUBMITTAL	

SEAL:

SHEET TITLE  
MATERIALS PLAN

# LM-101

1 - PAVING & SURFACING: DIVISION 32		
SYMBOL	DESCRIPTION	DETAIL
(1-06)	SYNLAWN PET SYSTEM	1/LS-502
(1-10)	DG AND FENCE	5/LS-502
(1-11)	MAIN MOUND	1/LS-200
(1-12)	CRESECENT MOUND	2/LS-200
(1-13)	DOG PAW MOUND	1/LS-201
2 - WALLS & FENCES: DIVISION 32		
SYMBOL	DESCRIPTION	DETAIL
(2-07)	AMERISTAR WIREWORKS PLUS FENCE	2/LS-502
3 - METALS: DIVISION 05		
SYMBOL	DESCRIPTION	DETAIL
(3-01)	ENTRY FEATURE	1/LS-500
(3-02)	DOG PAW "TOE" PLATFORM	2/LS-500
(3-05)	SHADE STRUCTURE	4/LS-501
5 - FURNISHINGS: DIVISION 32		
SYMBOL	DESCRIPTION	DETAIL
(5-08)	LINK BENCH	3/LS-502
(5-09)	NEOLIVIANO BENCH	4/LS-502
(5-10)	WAYFINDING SIGN	6/LS-502
8 - PLANTING: DIVISION 32		
SYMBOL	DESCRIPTION	DETAIL
(8-01)	TREE PLANTING	
(8-02)	SHRUB PLANTING	





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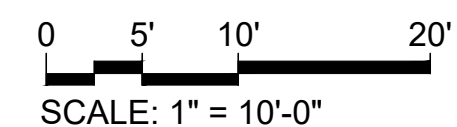
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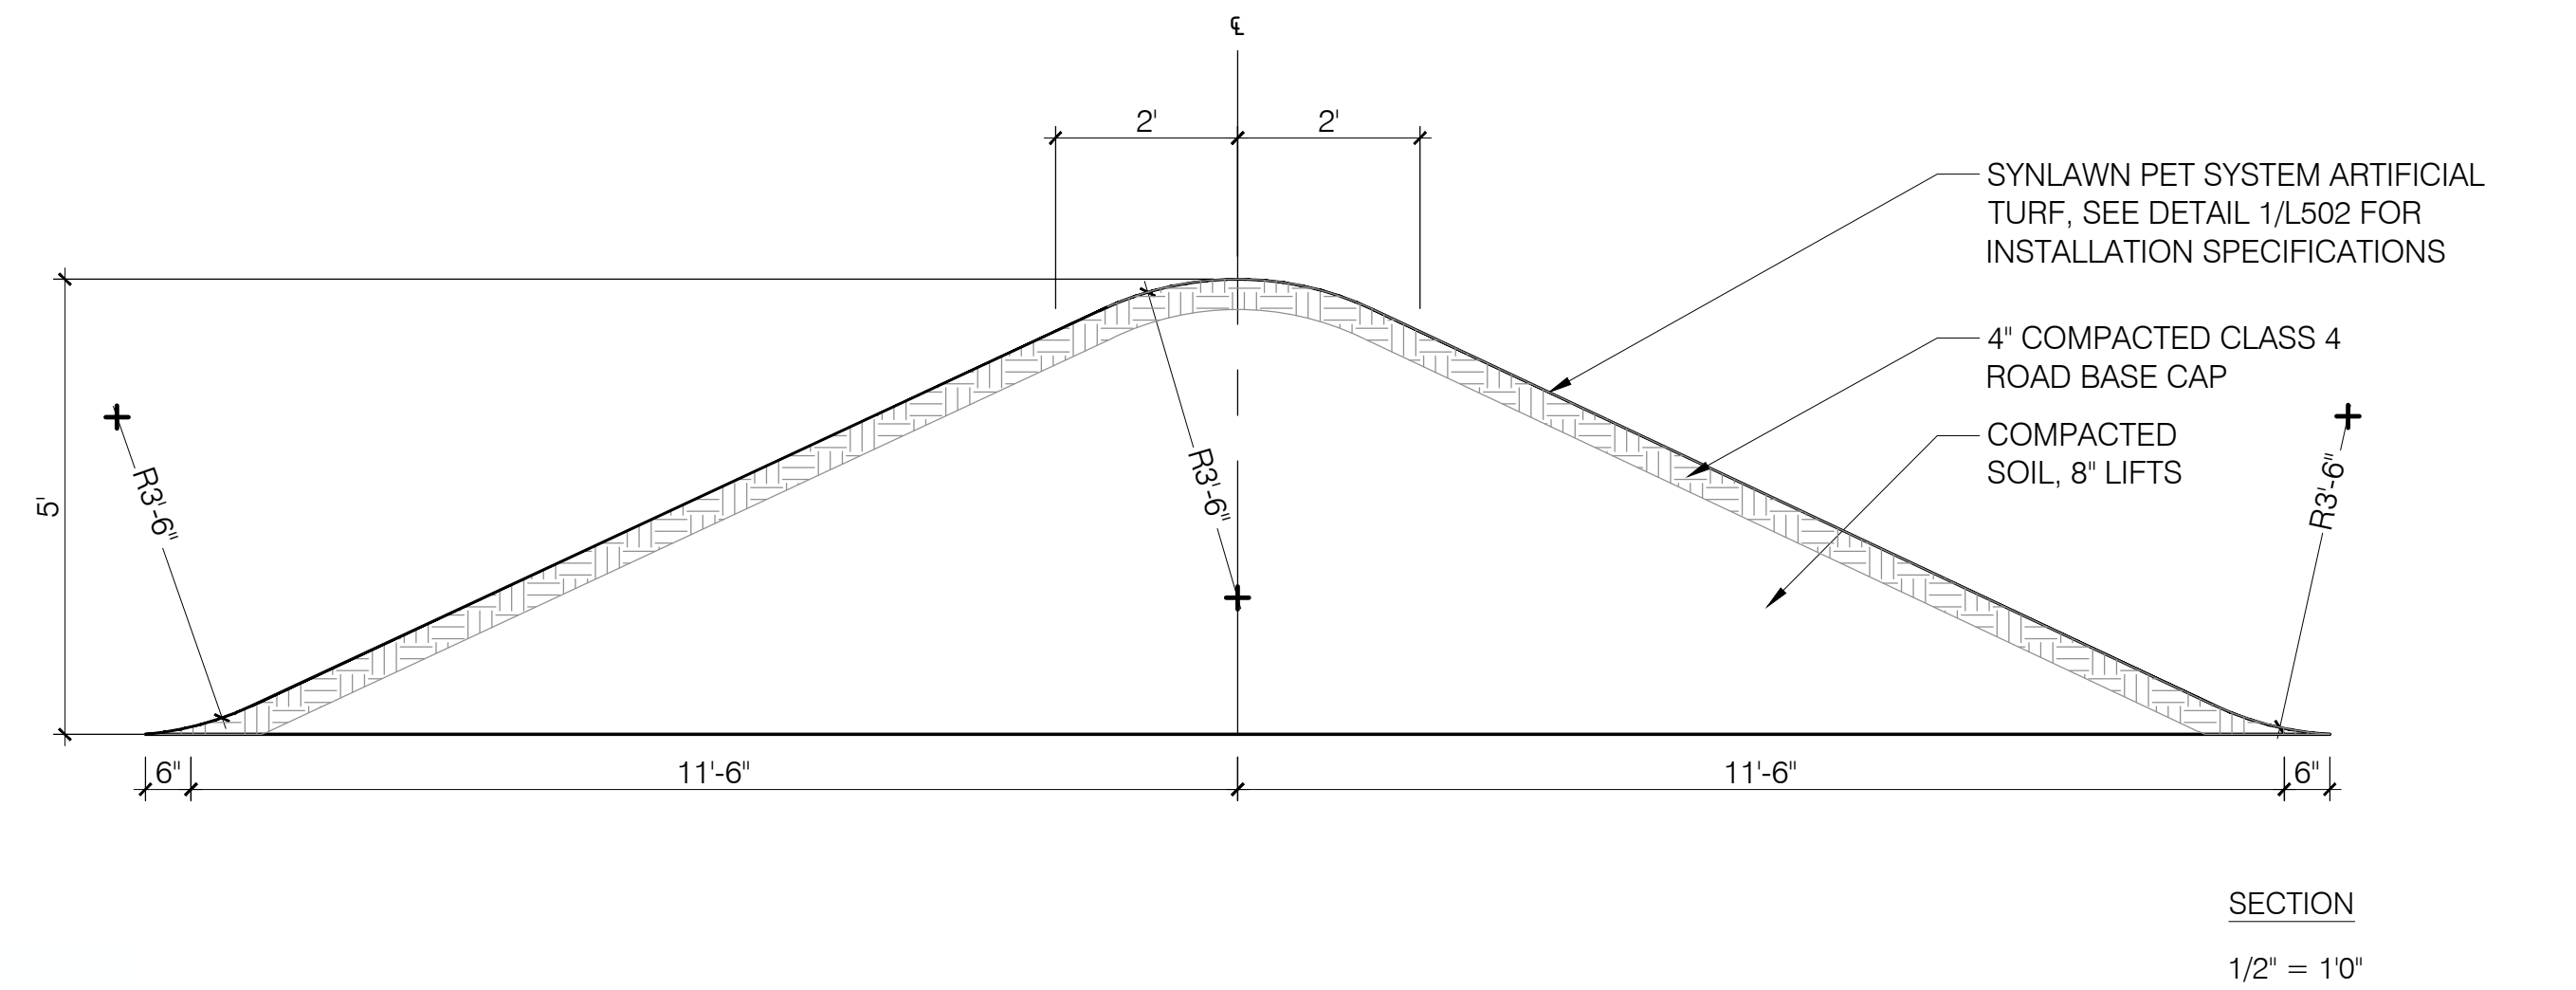
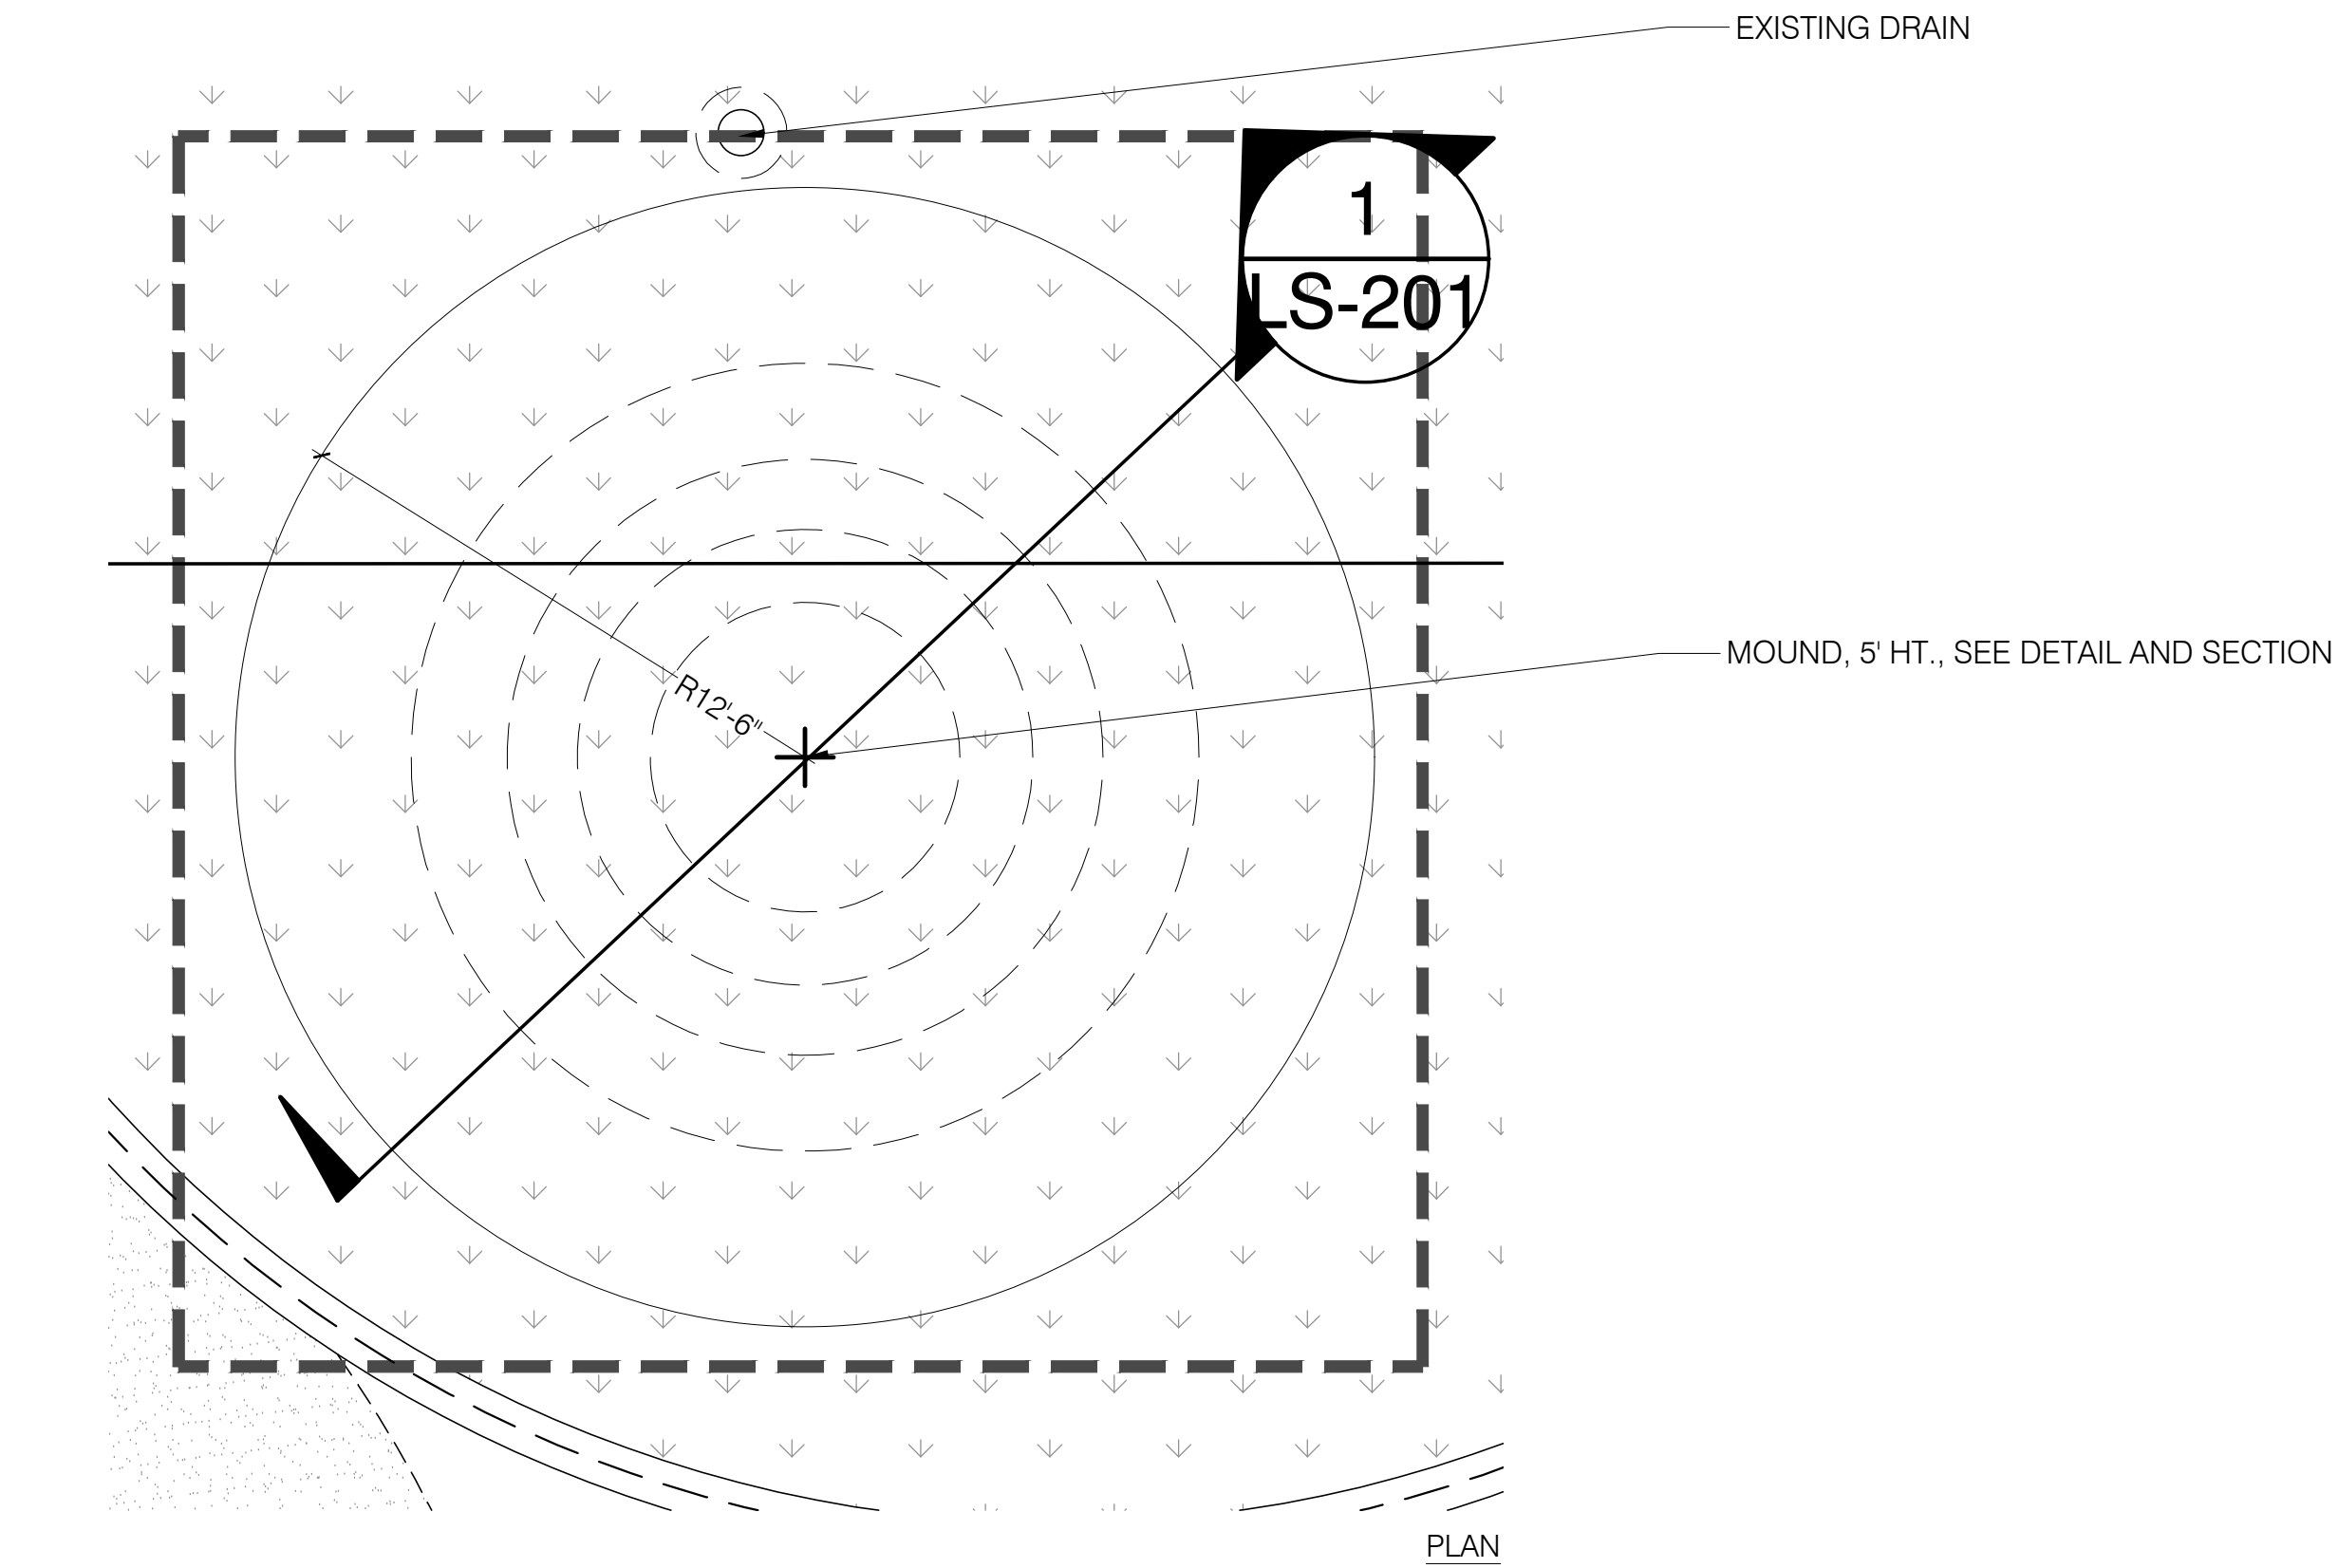
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LAYOUT PLAN

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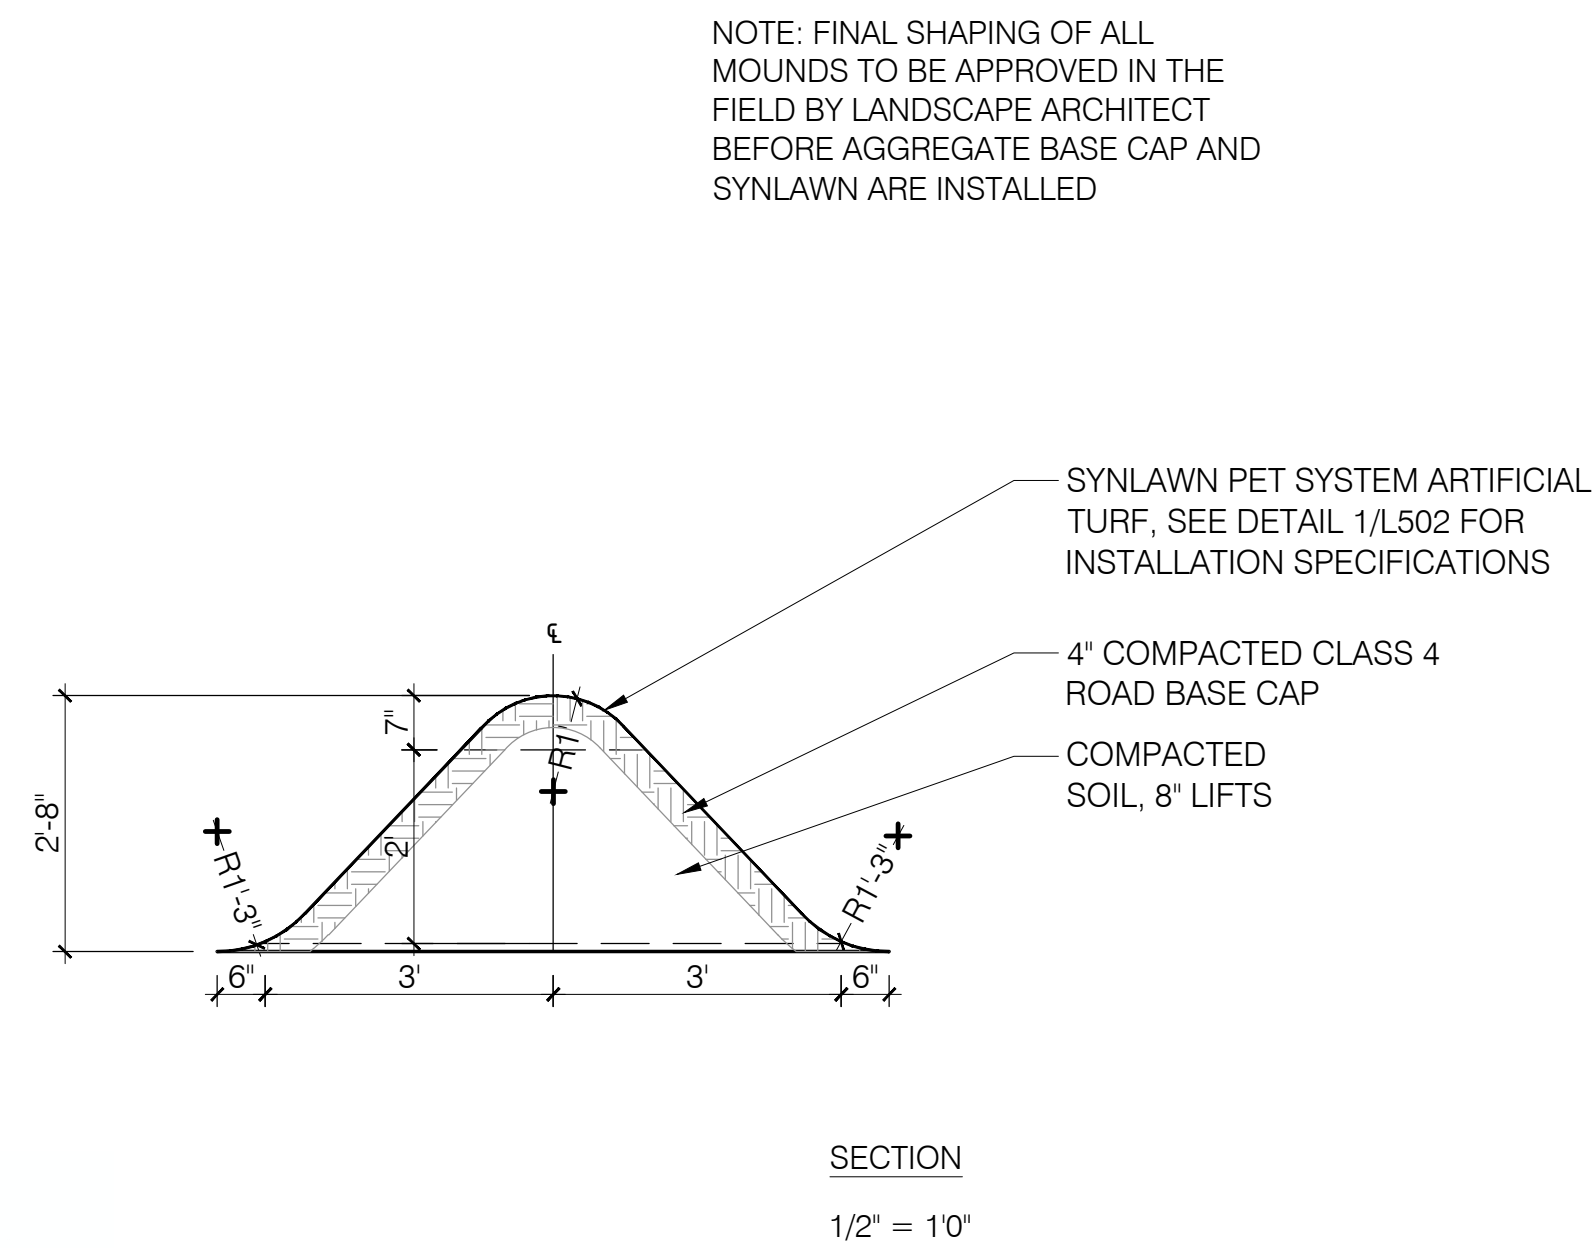
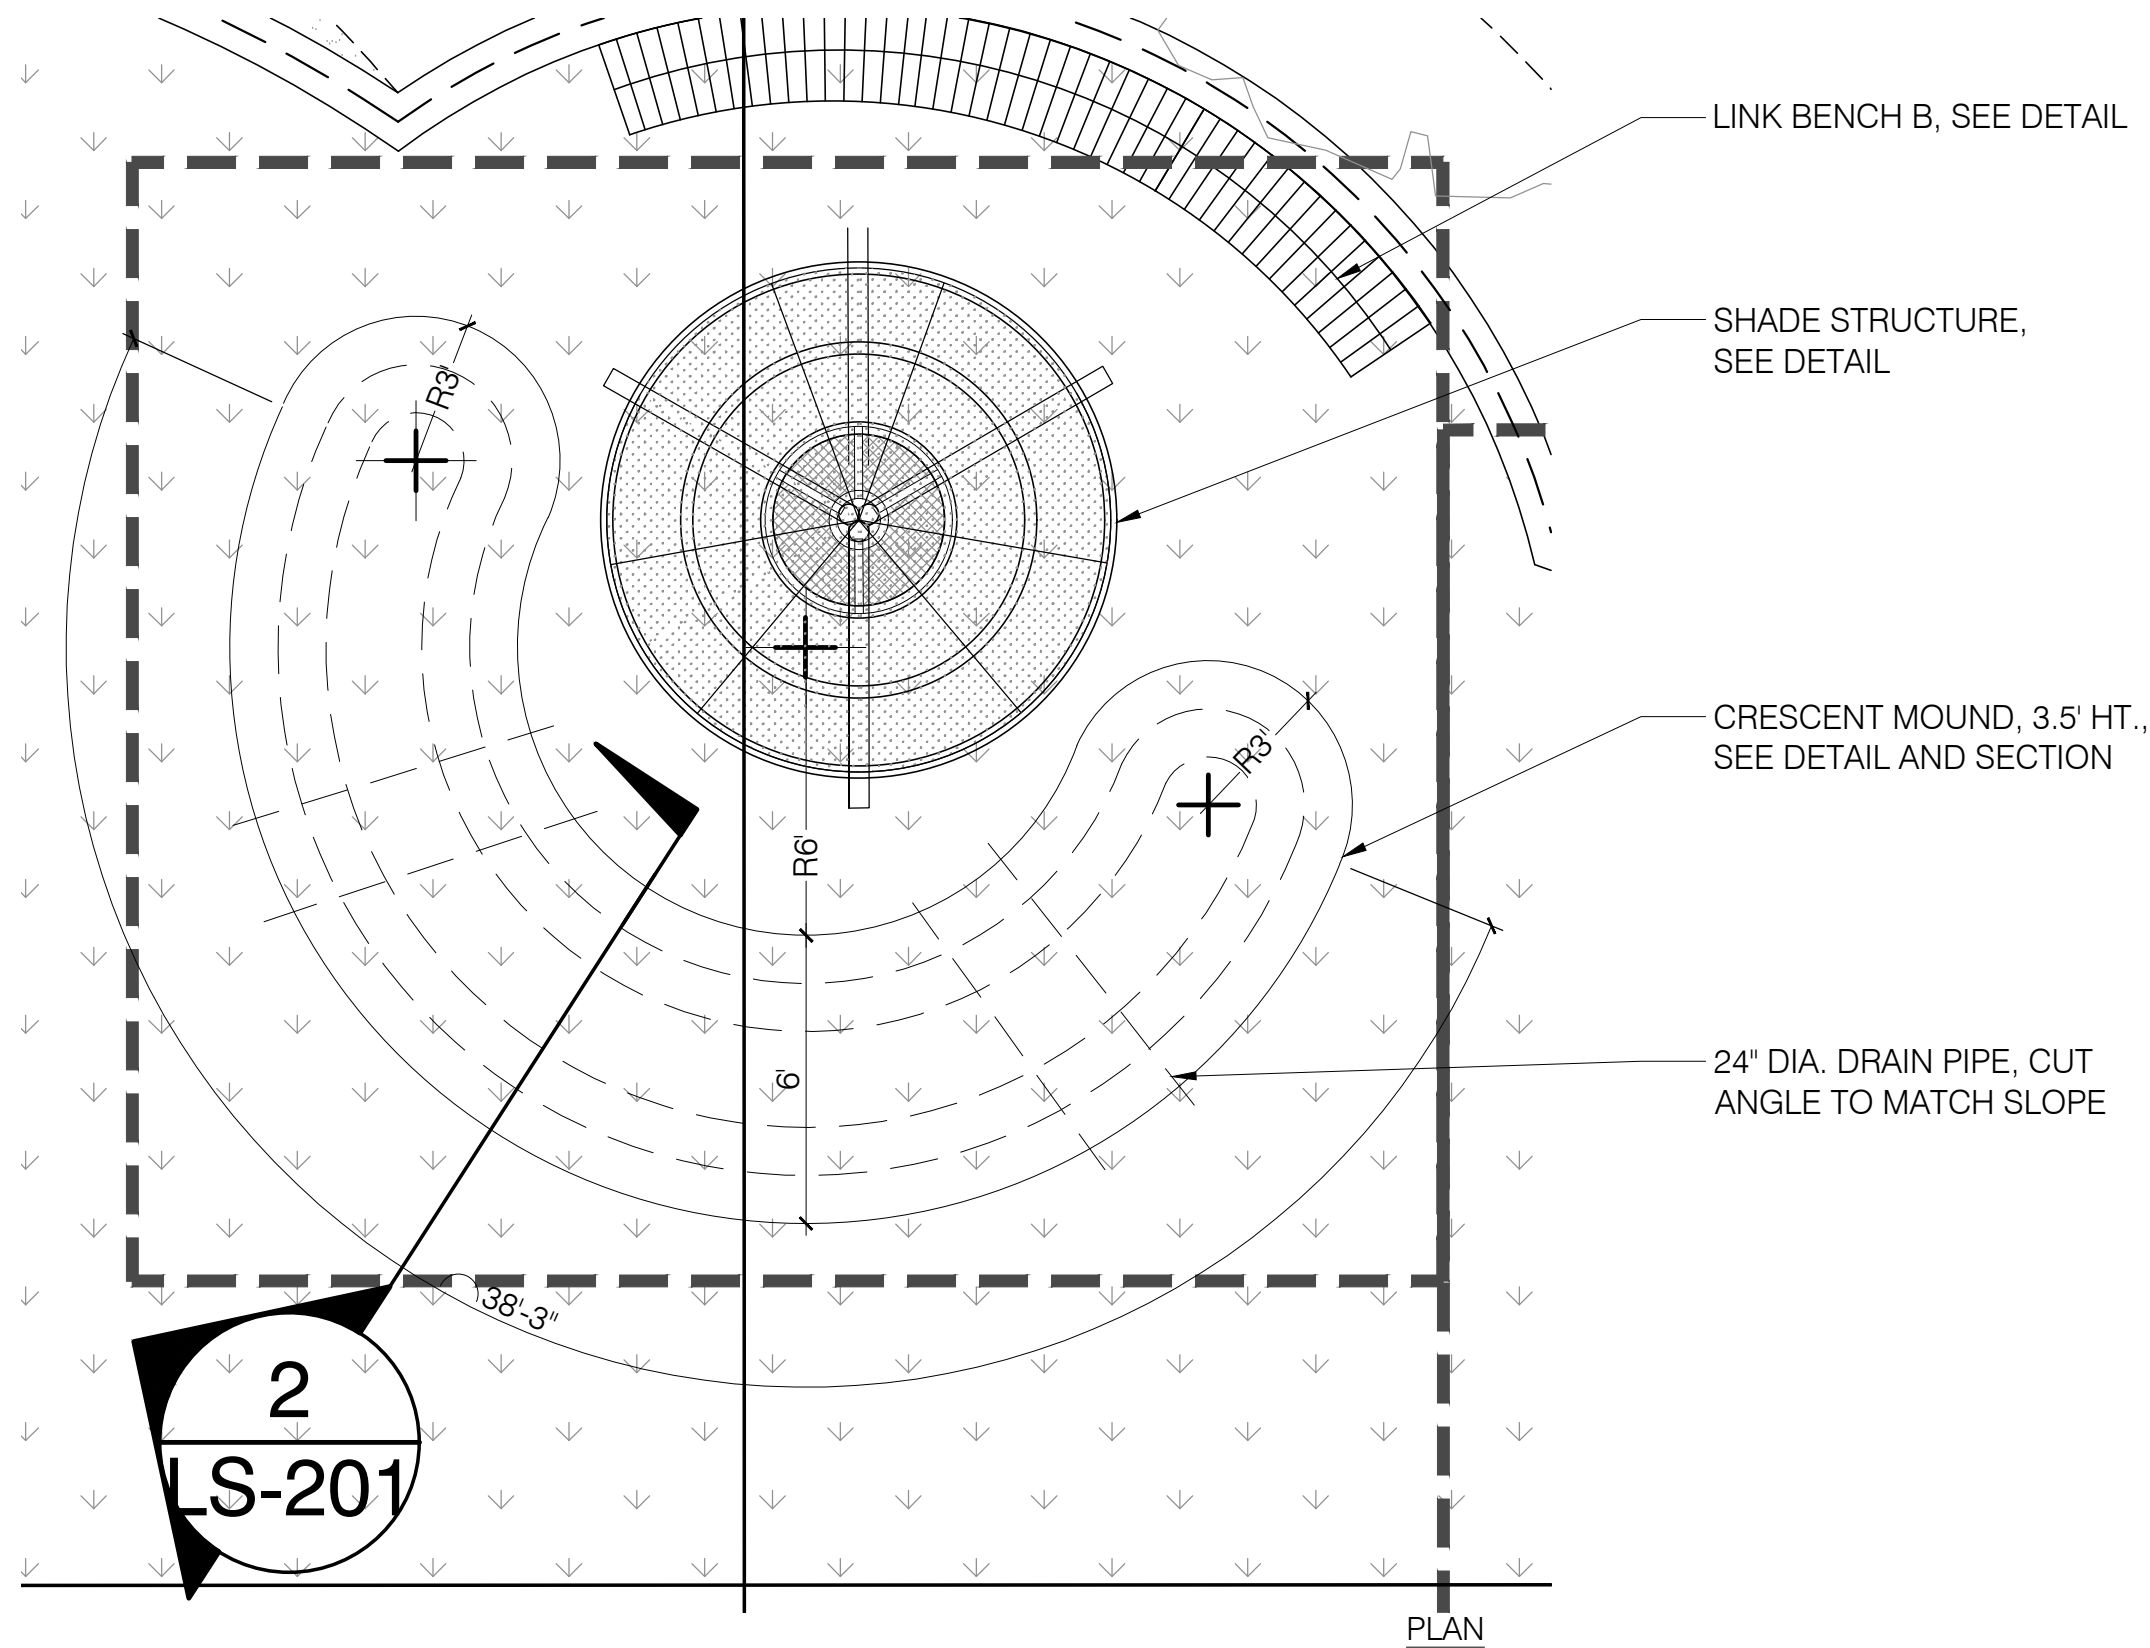
LS-101





NOTE: FINAL SHAPING OF ALL MOUNDS TO BE APPROVED IN THE FIELD BY LANDSCAPE ARCHITECT BEFORE AGGREGATE BASE CAP AND SYNLAWN ARE INSTALLED

1 ENLARGEMENT - MAIN MOUND  
1/4" = 1'



NOTE: FINAL SHAPING OF ALL MOUNDS TO BE APPROVED IN THE FIELD BY LANDSCAPE ARCHITECT BEFORE AGGREGATE BASE CAP AND SYNLAWN ARE INSTALLED

2 ENLARGEMENT - CRESCENT MOUND  
1/4" = 1'



CHILDREN'S HOSPITAL COLORADO  
**CANINE RESPITE AREA**

REVISIONS:

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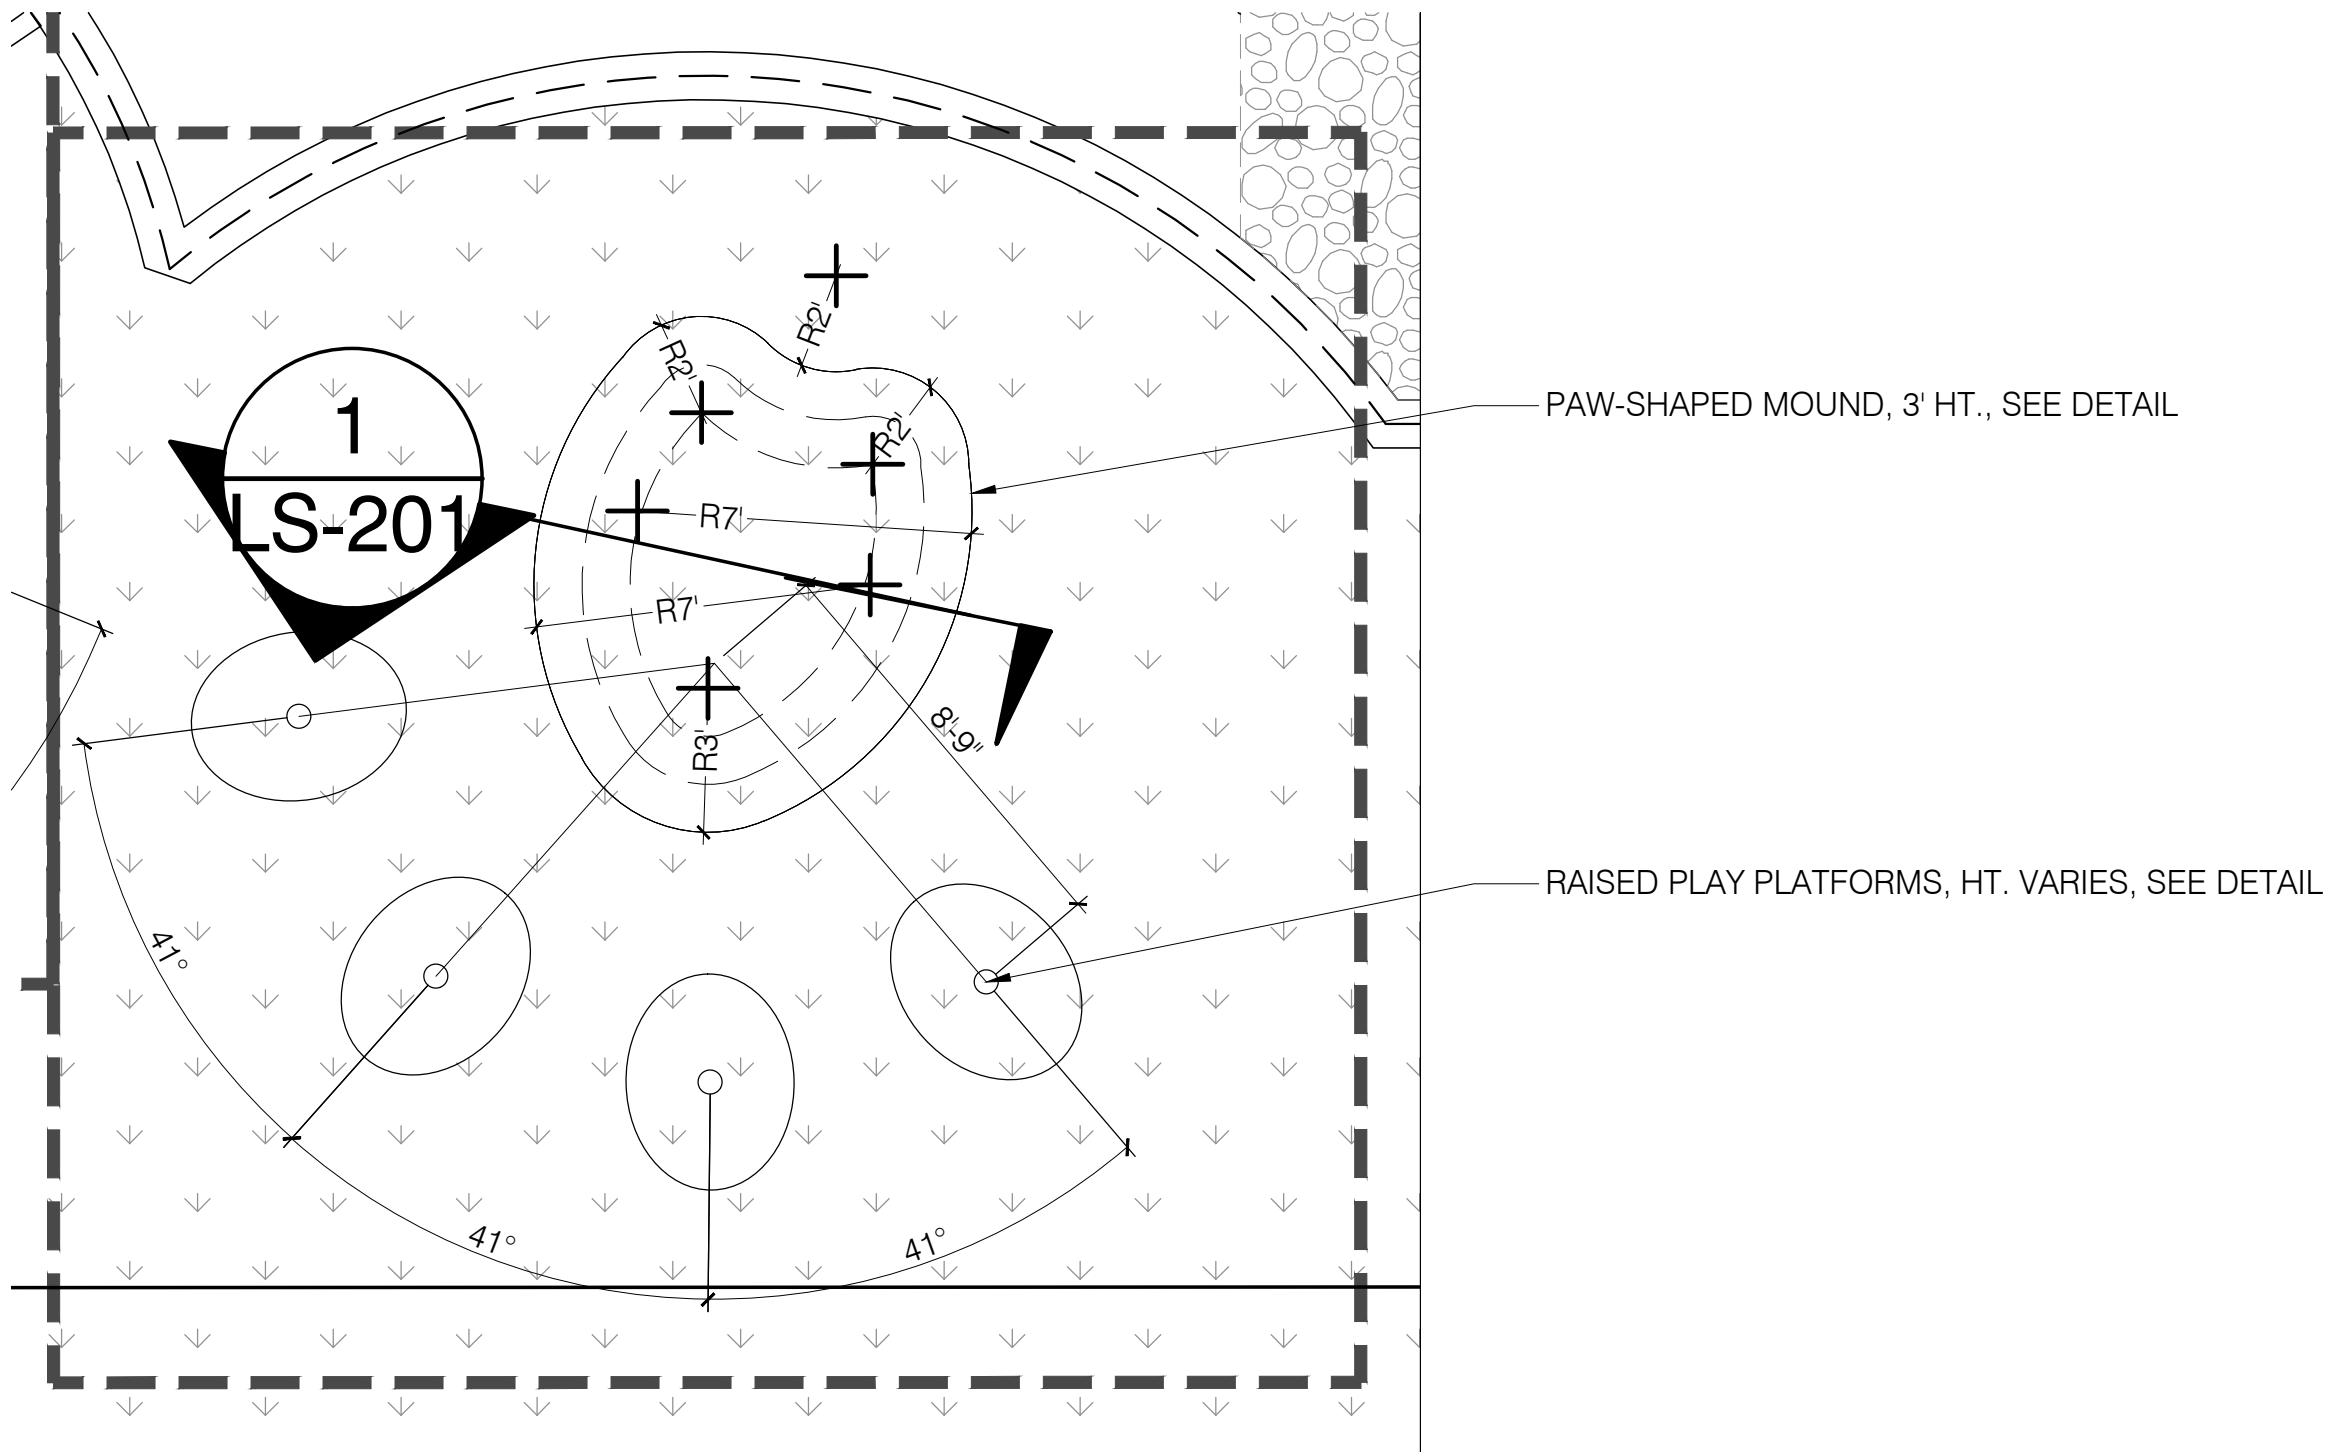
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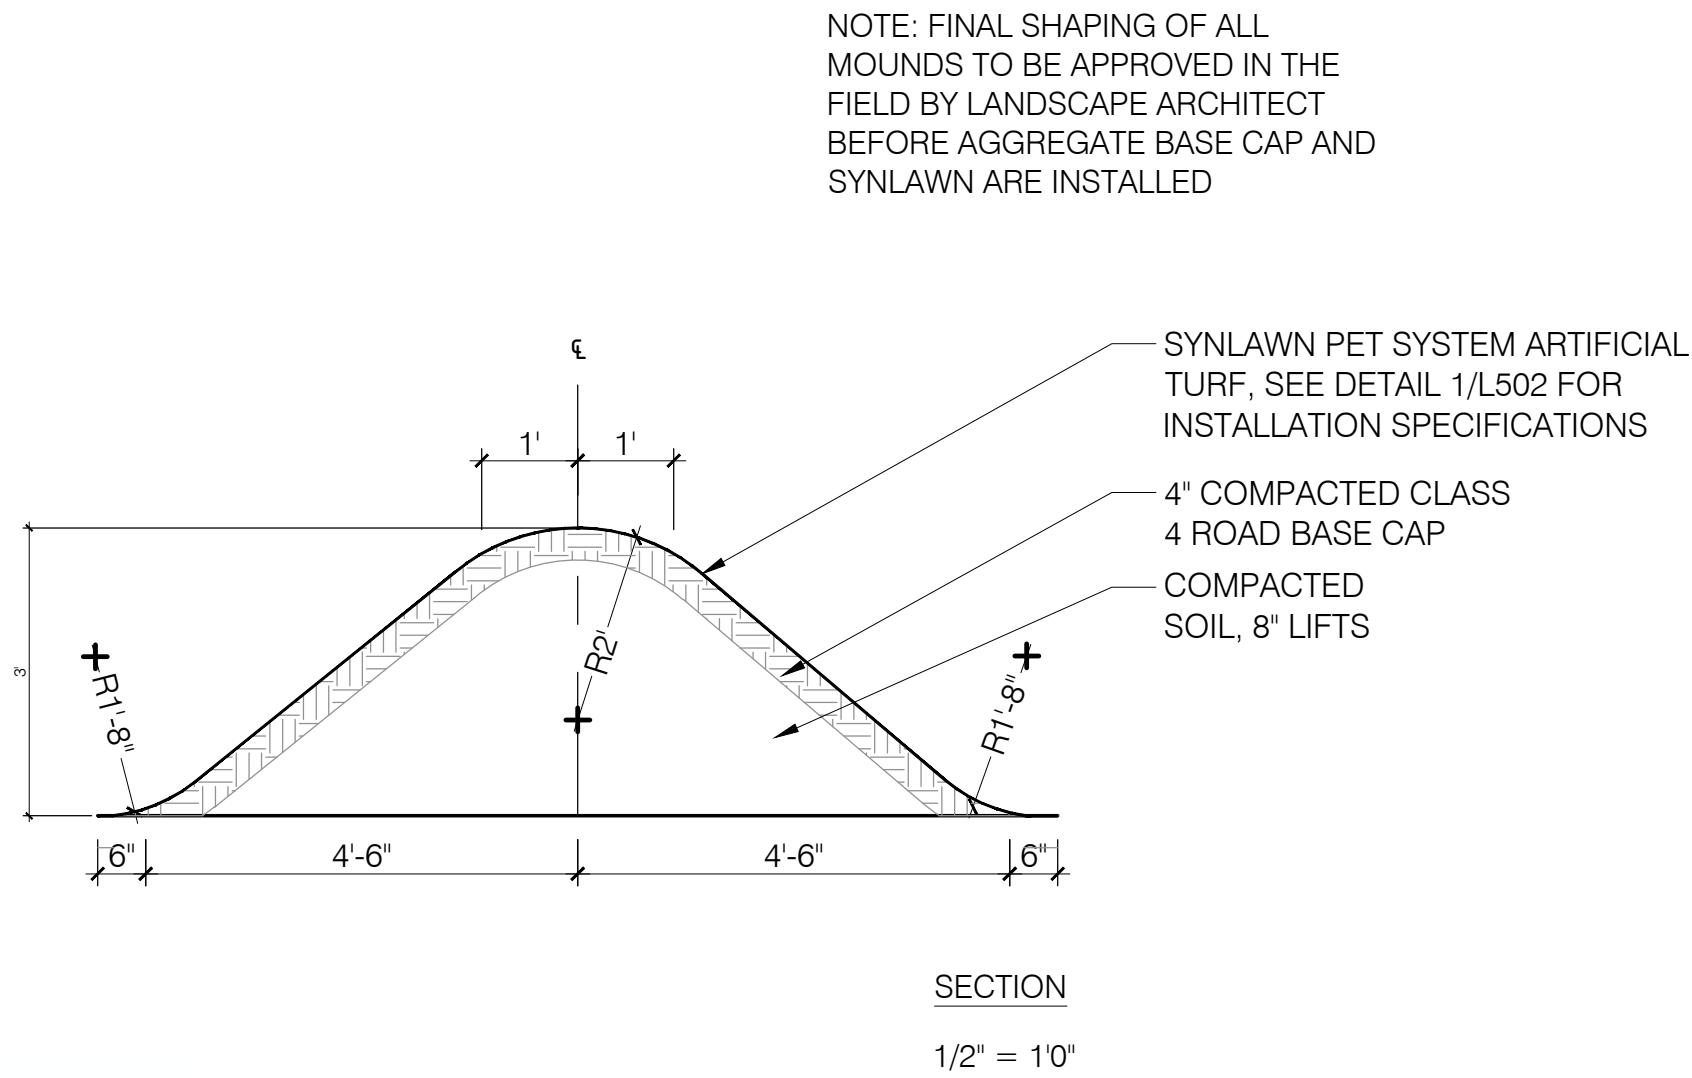
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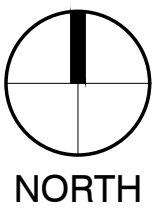




1 ENLARGEMENT - DOG PAW MOUND  
1/4" = 1'



NOTE: FINAL SHAPING OF ALL  
MOUNDS TO BE APPROVED IN THE  
FIELD BY LANDSCAPE ARCHITECT  
BEFORE AGGREGATE BASE CAP AND  
SYNLAWN ARE INSTALLED



CHILDREN'S HOSPITAL COLORADO  
**CANINE RESPITE AREA**

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SHEET TITLE  
SITE ENLARGEMENT

SHEET NUMBER

LS-202





1 ILLUSTRATIVE SECTION ELEVATION A  
1" = 10'-0"



2 ILLUSTRATIVE SECTION ELEVATION B  
1" = 10'-0"

CHILDREN'S HOSPITAL COLORADO  
**CANINE RESPITE AREA**

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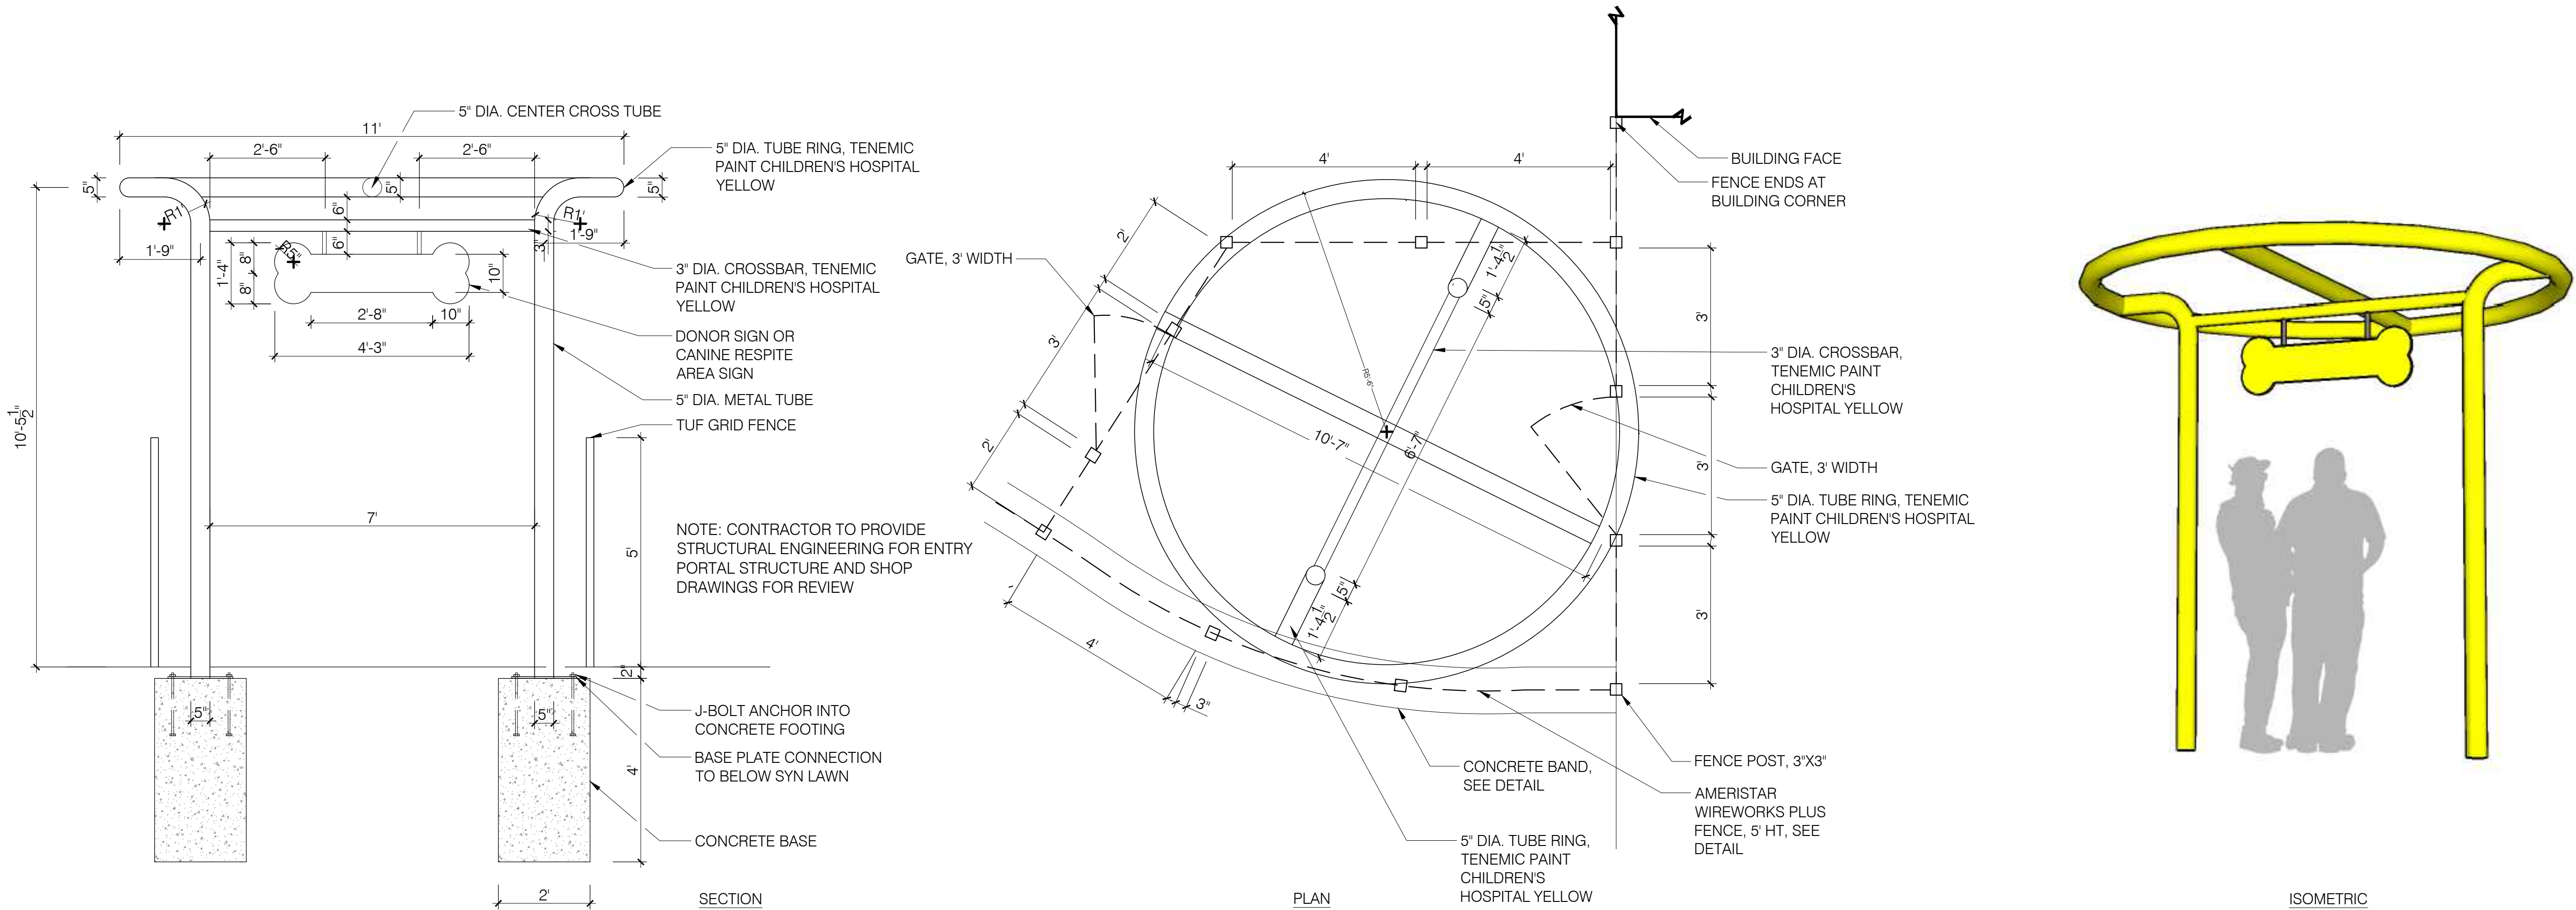
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SITE SECTIONS

SHEET NUMBER

**LS-203**






1

ENTRY PORTAL FEATURE


1/2" = 1'-0"

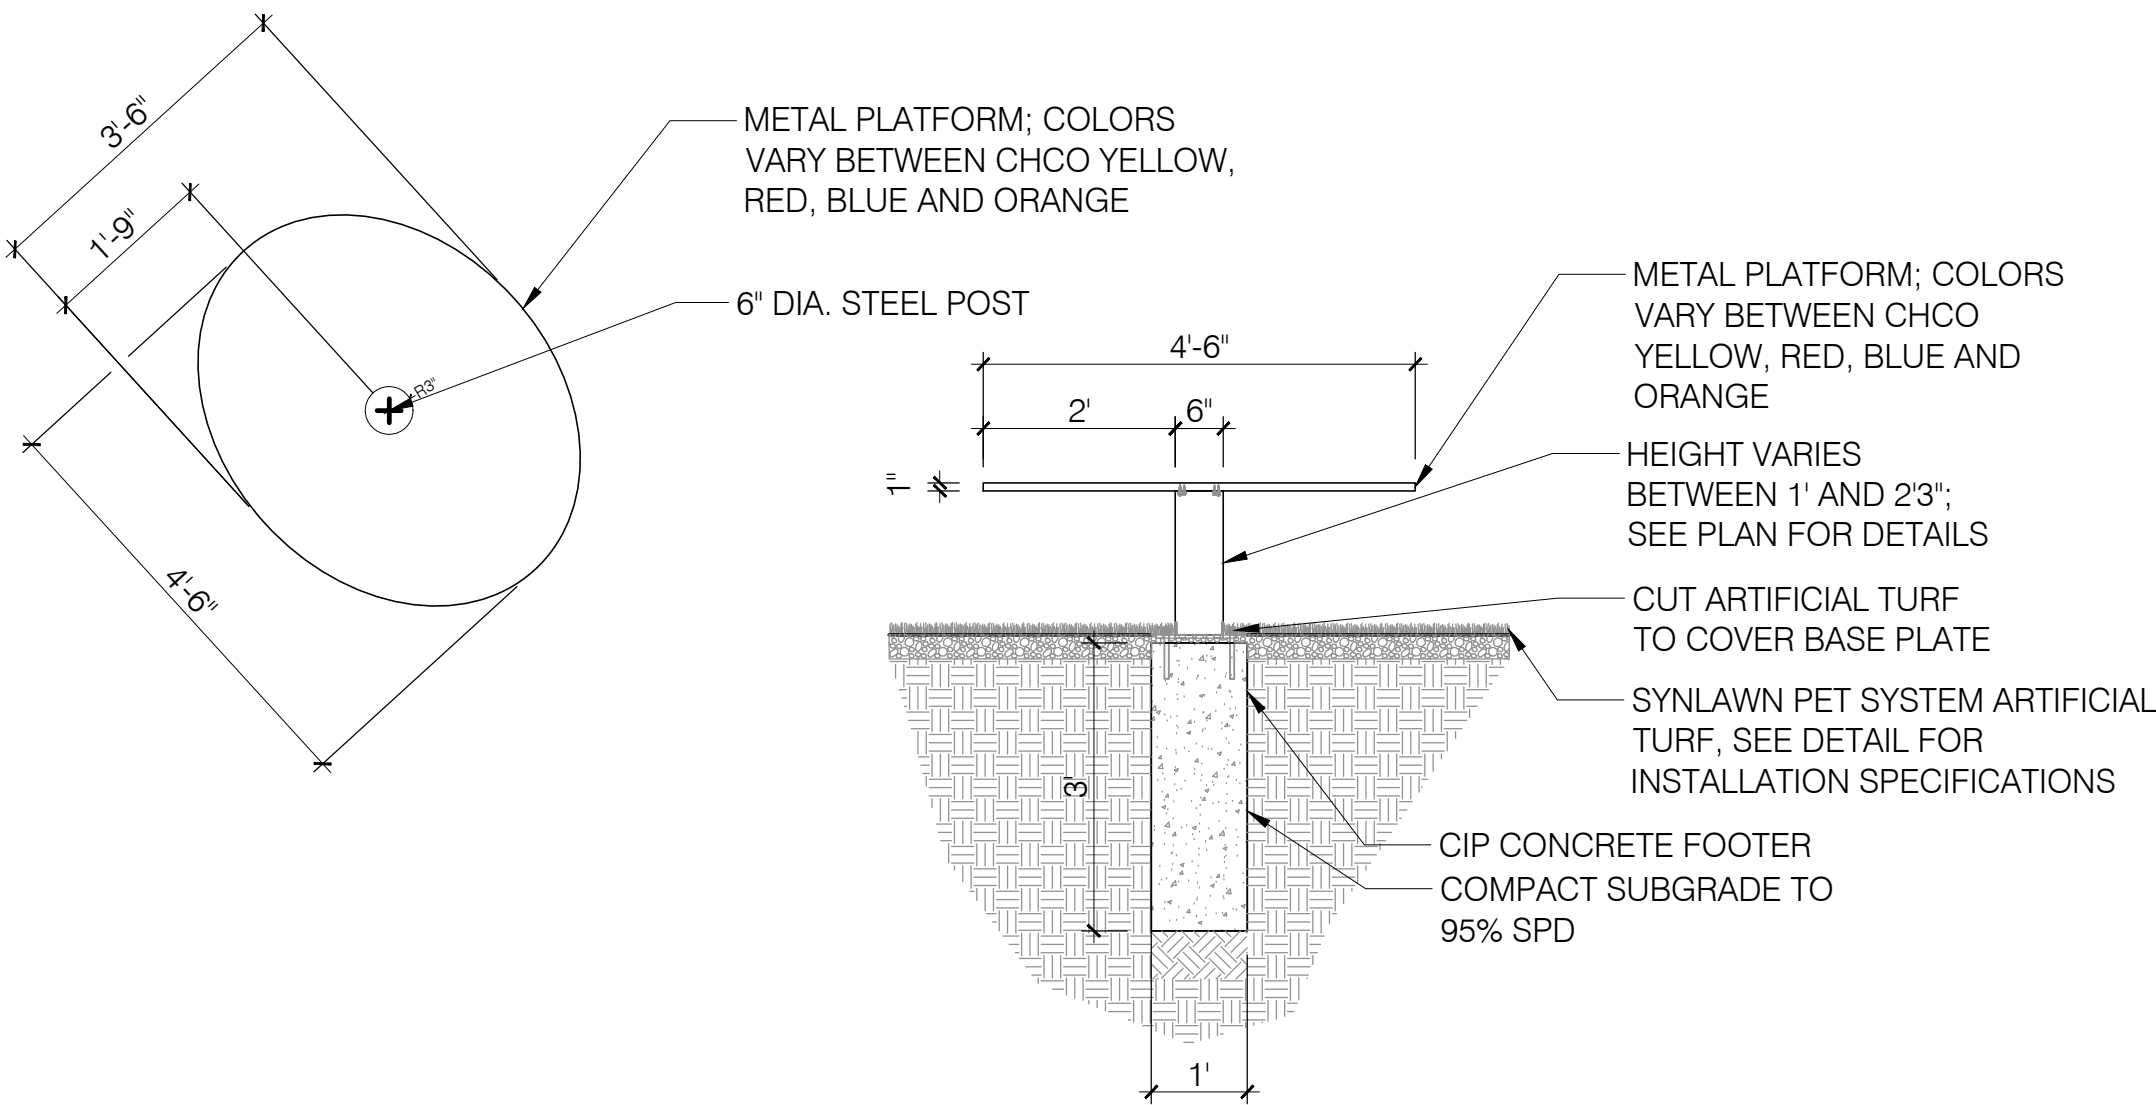

2

DOG PAW "TOE" PLATFORM

1/2" = 1'-0"

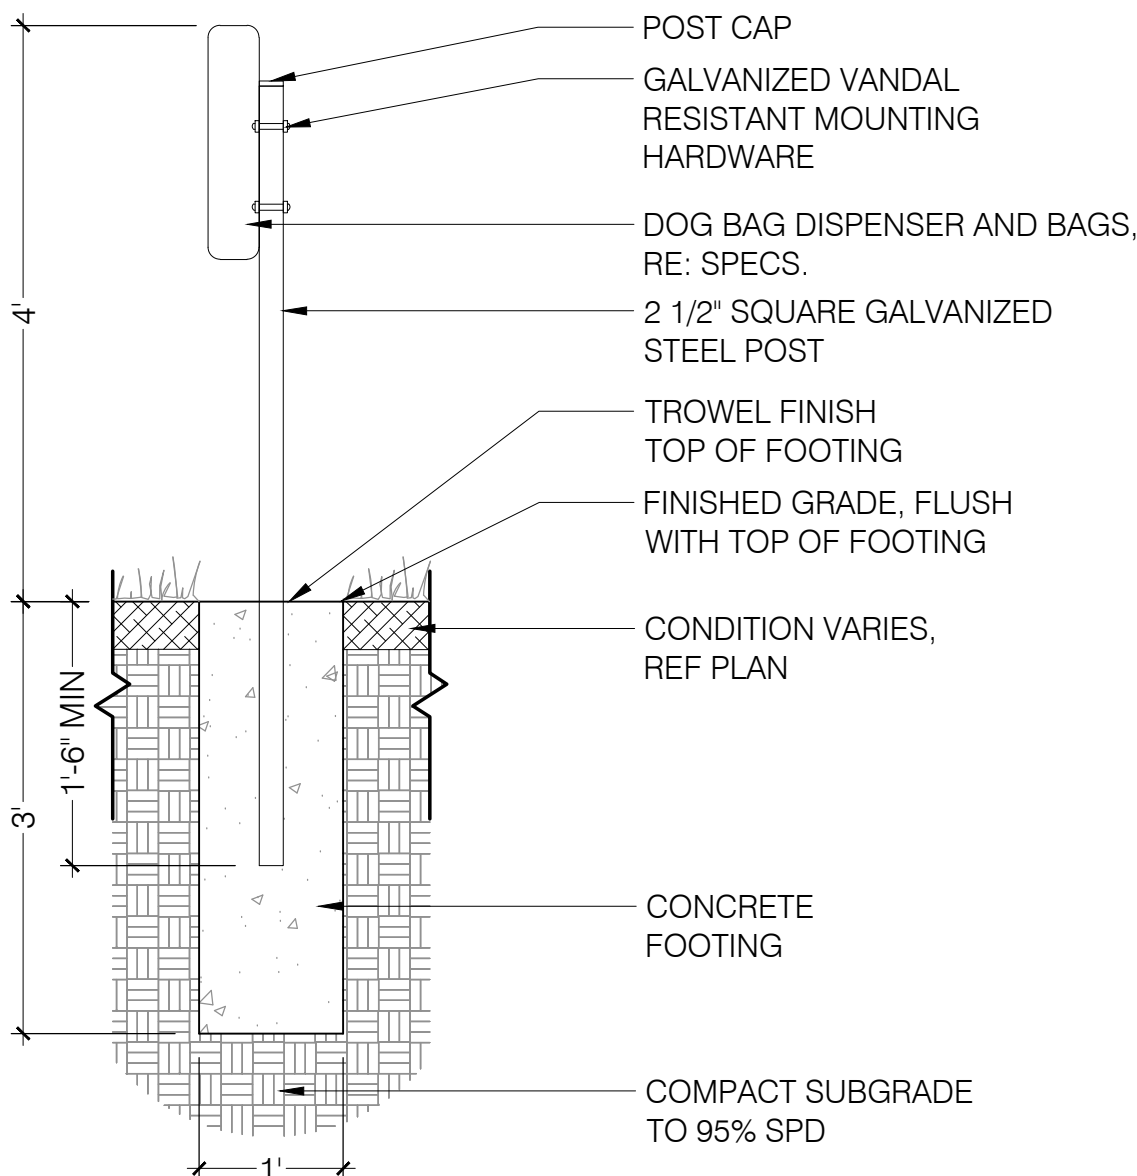

3

DOG BAG DISPENSER

3/4" = 1'-0"

MANUFACTURER: DUMOR  
SIZE: 22 GAL.  
MODELS: TRASH: #287-32 SH SO W/ SHIELDS  
RECYCLE: #287-32 SH RC2 W/ SHIELDS MIXED RECYCLING  
COLOR / MATERIAL: BLACK / STEEL  
SURFACE MOUNT



NOTES:  
1. INSTALL PER MANUFACTURERS RECOMMENDATIONS.

4

LITTER RECEPTACLE

1" = 1'-0"

CHILDREN'S HOSPITAL COLORADO  
**CANINE RESPITE AREA**

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SHEET TITLE  
SITE DETAILS

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**LS-501**



CHILDREN'S HOSPITAL COLORADO

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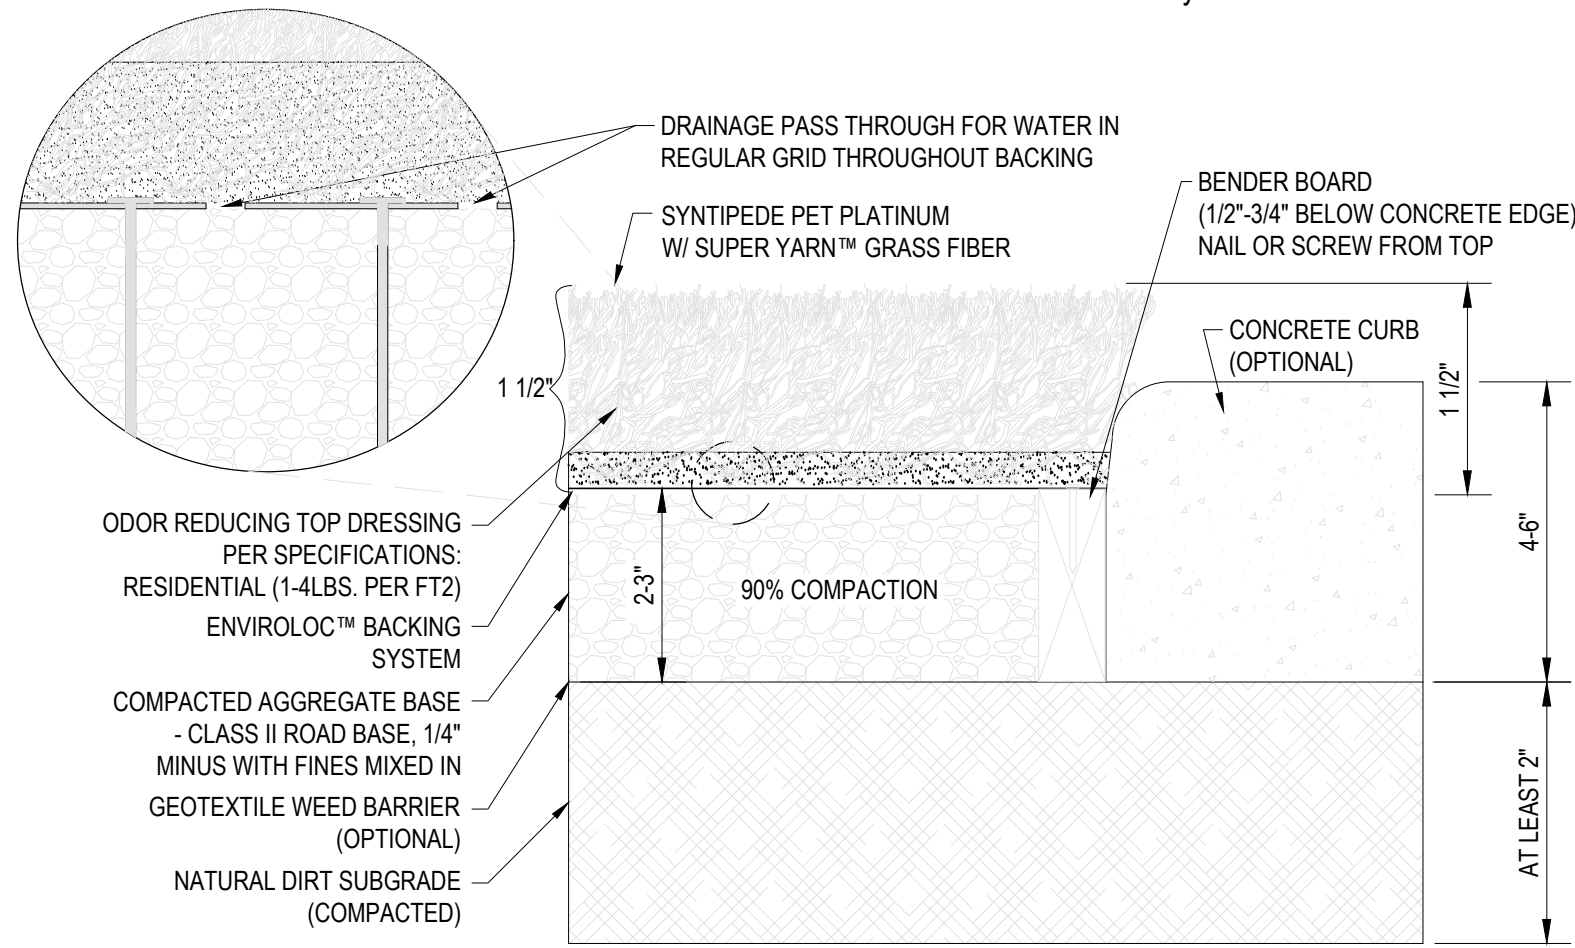
LS-502







SYNLAWN  
2680 ABUTMENT ROAD SE  
DALTON, GA 30721  
TOLL FREE: 1-866-SYNLAWN  
FAX: (706) 277-1128  
www.synlawn.com



SPECIFICATIONS		FALL RATING:	
PRODUCT SKU:	SYNLAWN PET PLATINUM	PERMEABILITY:	IPEMA CERTIFIED
GRASS ZONE YARN/COLOR:	PE SUPER YARN™ FIELD / APPLE	FEATURES:	> 1,200 INCHES PER /SY
GRASS ZONE DENIER:	10,000/6		SANITIZED®, ENVIROLOC™, STATBLOCK™,
THATCH ZONE YARN/COLOR:	FIELD GREEN/BEIGE		DUALCHILL™, DELUSTER, UV STABILIZERS
THATCH ZONE DENIER:	5,040/12	TEST DATA:	ASTM E108 CLASS A FIRE RATING,
GRASS ZONE YARN SHAPE:	OMEGA		ASTM F1292, ASTM F1551, ASTM F1951
FINISHED PILE HEIGHT:	1 1/2"	<div>SECURING THE GRASS TO THE BASE</div>	
FINISHED PILE WEIGHT:	80 OZ.		
BACKING:	15/18 PP 2-PART, 20 OZ ENVIROLOC™		
TUFT GAUGE:	3/8"		
TOTAL WEIGHT:	106 OZ.		
TUFF BIND:	> 8 LBS.		

- NOTES:
1. FOR PET INSTALLS IT IS RECOMMENDED TO RINSE DAILY TO PREVENT ODORS REGARDLESS OF PET DEODORIZER USE.
  2. INSTALLATION TO BE COMPLETED IN ACCORDANCE WITH SPECIFICATIONS BY FACTORY AUTHORIZED INSTALLERS.
  3. DO NOT SCALE DRAWINGS.
  4. CONTRACTORS NOTE: FOR PRODUCT AND COMPANY INFORMATION VISIT [www.CADdetails.com/info](http://www.CADdetails.com/info)




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## 1 SYNLAWN PET SYSTEM

1" = 1'-0"

MANUFACTURER: LANDSCAPE FORMS  
MODEL: NEOLIVIANO BENCH, BACKED, 69 IN,  
SURFACE MOUNT, WOOD  
NOTES:  
INSTALL PER MANUFACTURER'S SPECIFICATIONS

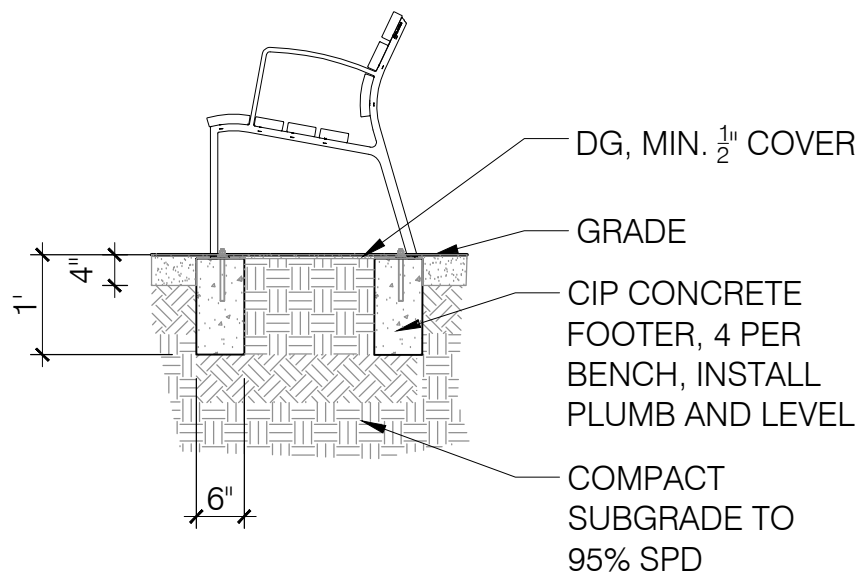


## 4 NEOLIVIANO BENCH

1/2" = 1'-0"

## 2 AMERISTAR WIREWORKS PLUS FENCE

1/2" = 1'-0"

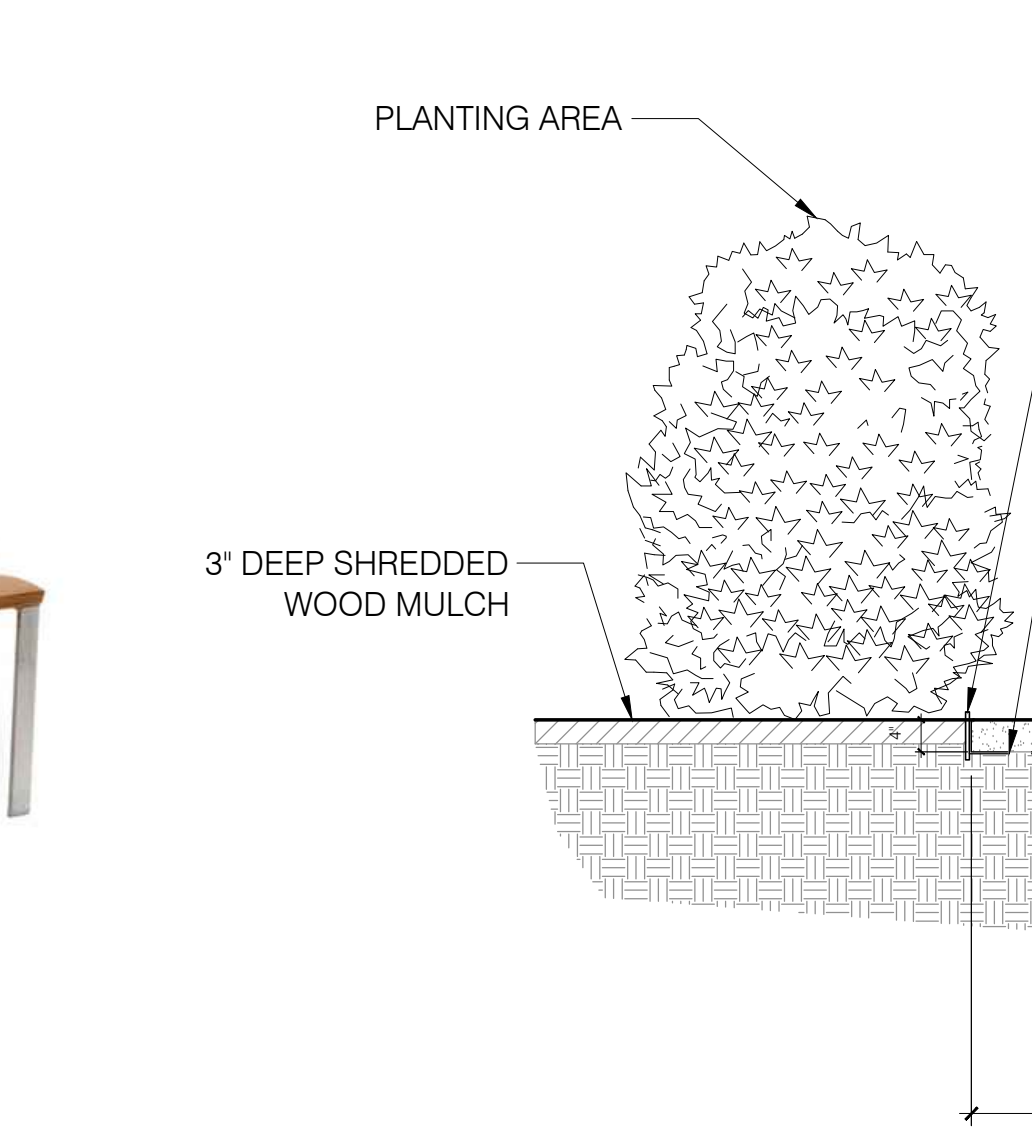


## 5 DG AND FENCE

1/2" = 1'-0"

## 3 LINK BENCH

N.T.S.

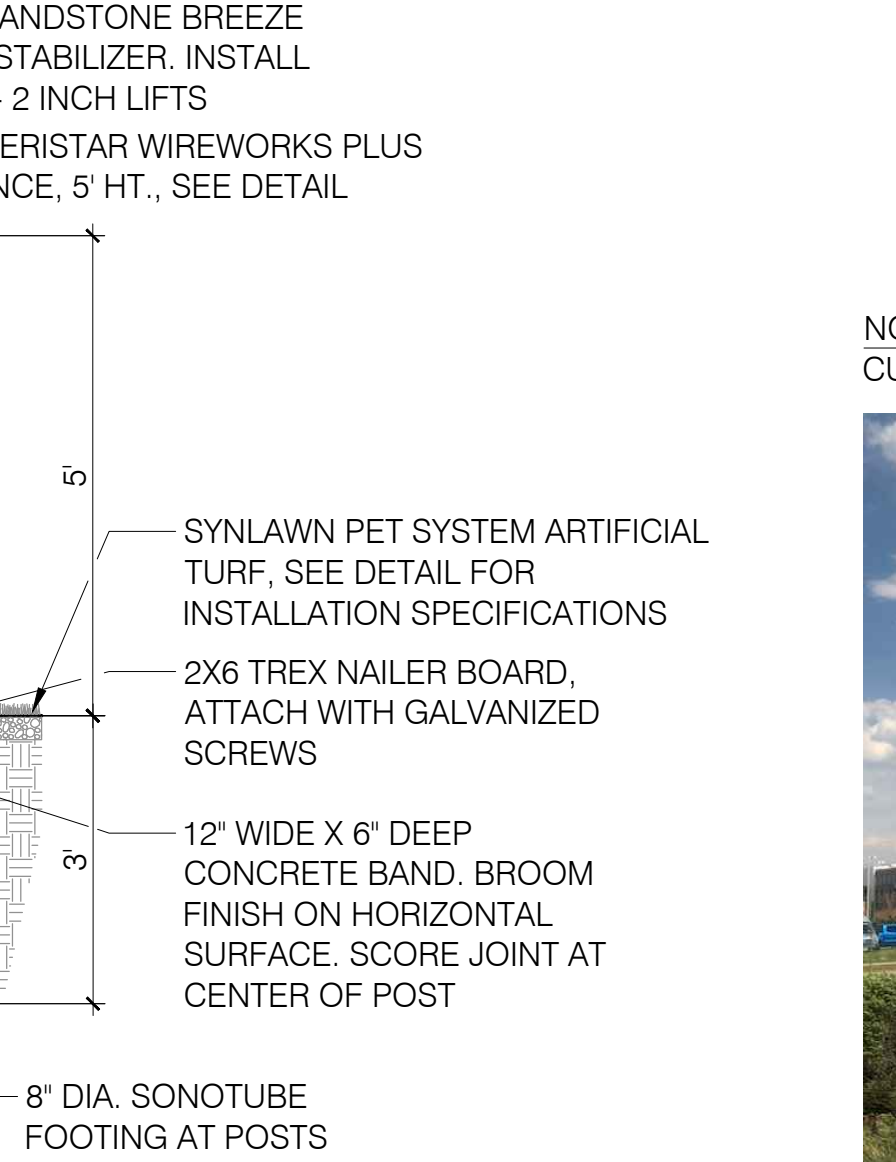

## 6 WAYFINDING SIGN

N.T.S.

NOTES:  
CUSTOM FABRICATED



# CHILDREN'S HOSPITAL COLORADO CANINE RESPITE AREA

## REVISIONS:

No.	DATE	DESCRIPTION	BY
	11-03-20	DD SUBMITTAL	

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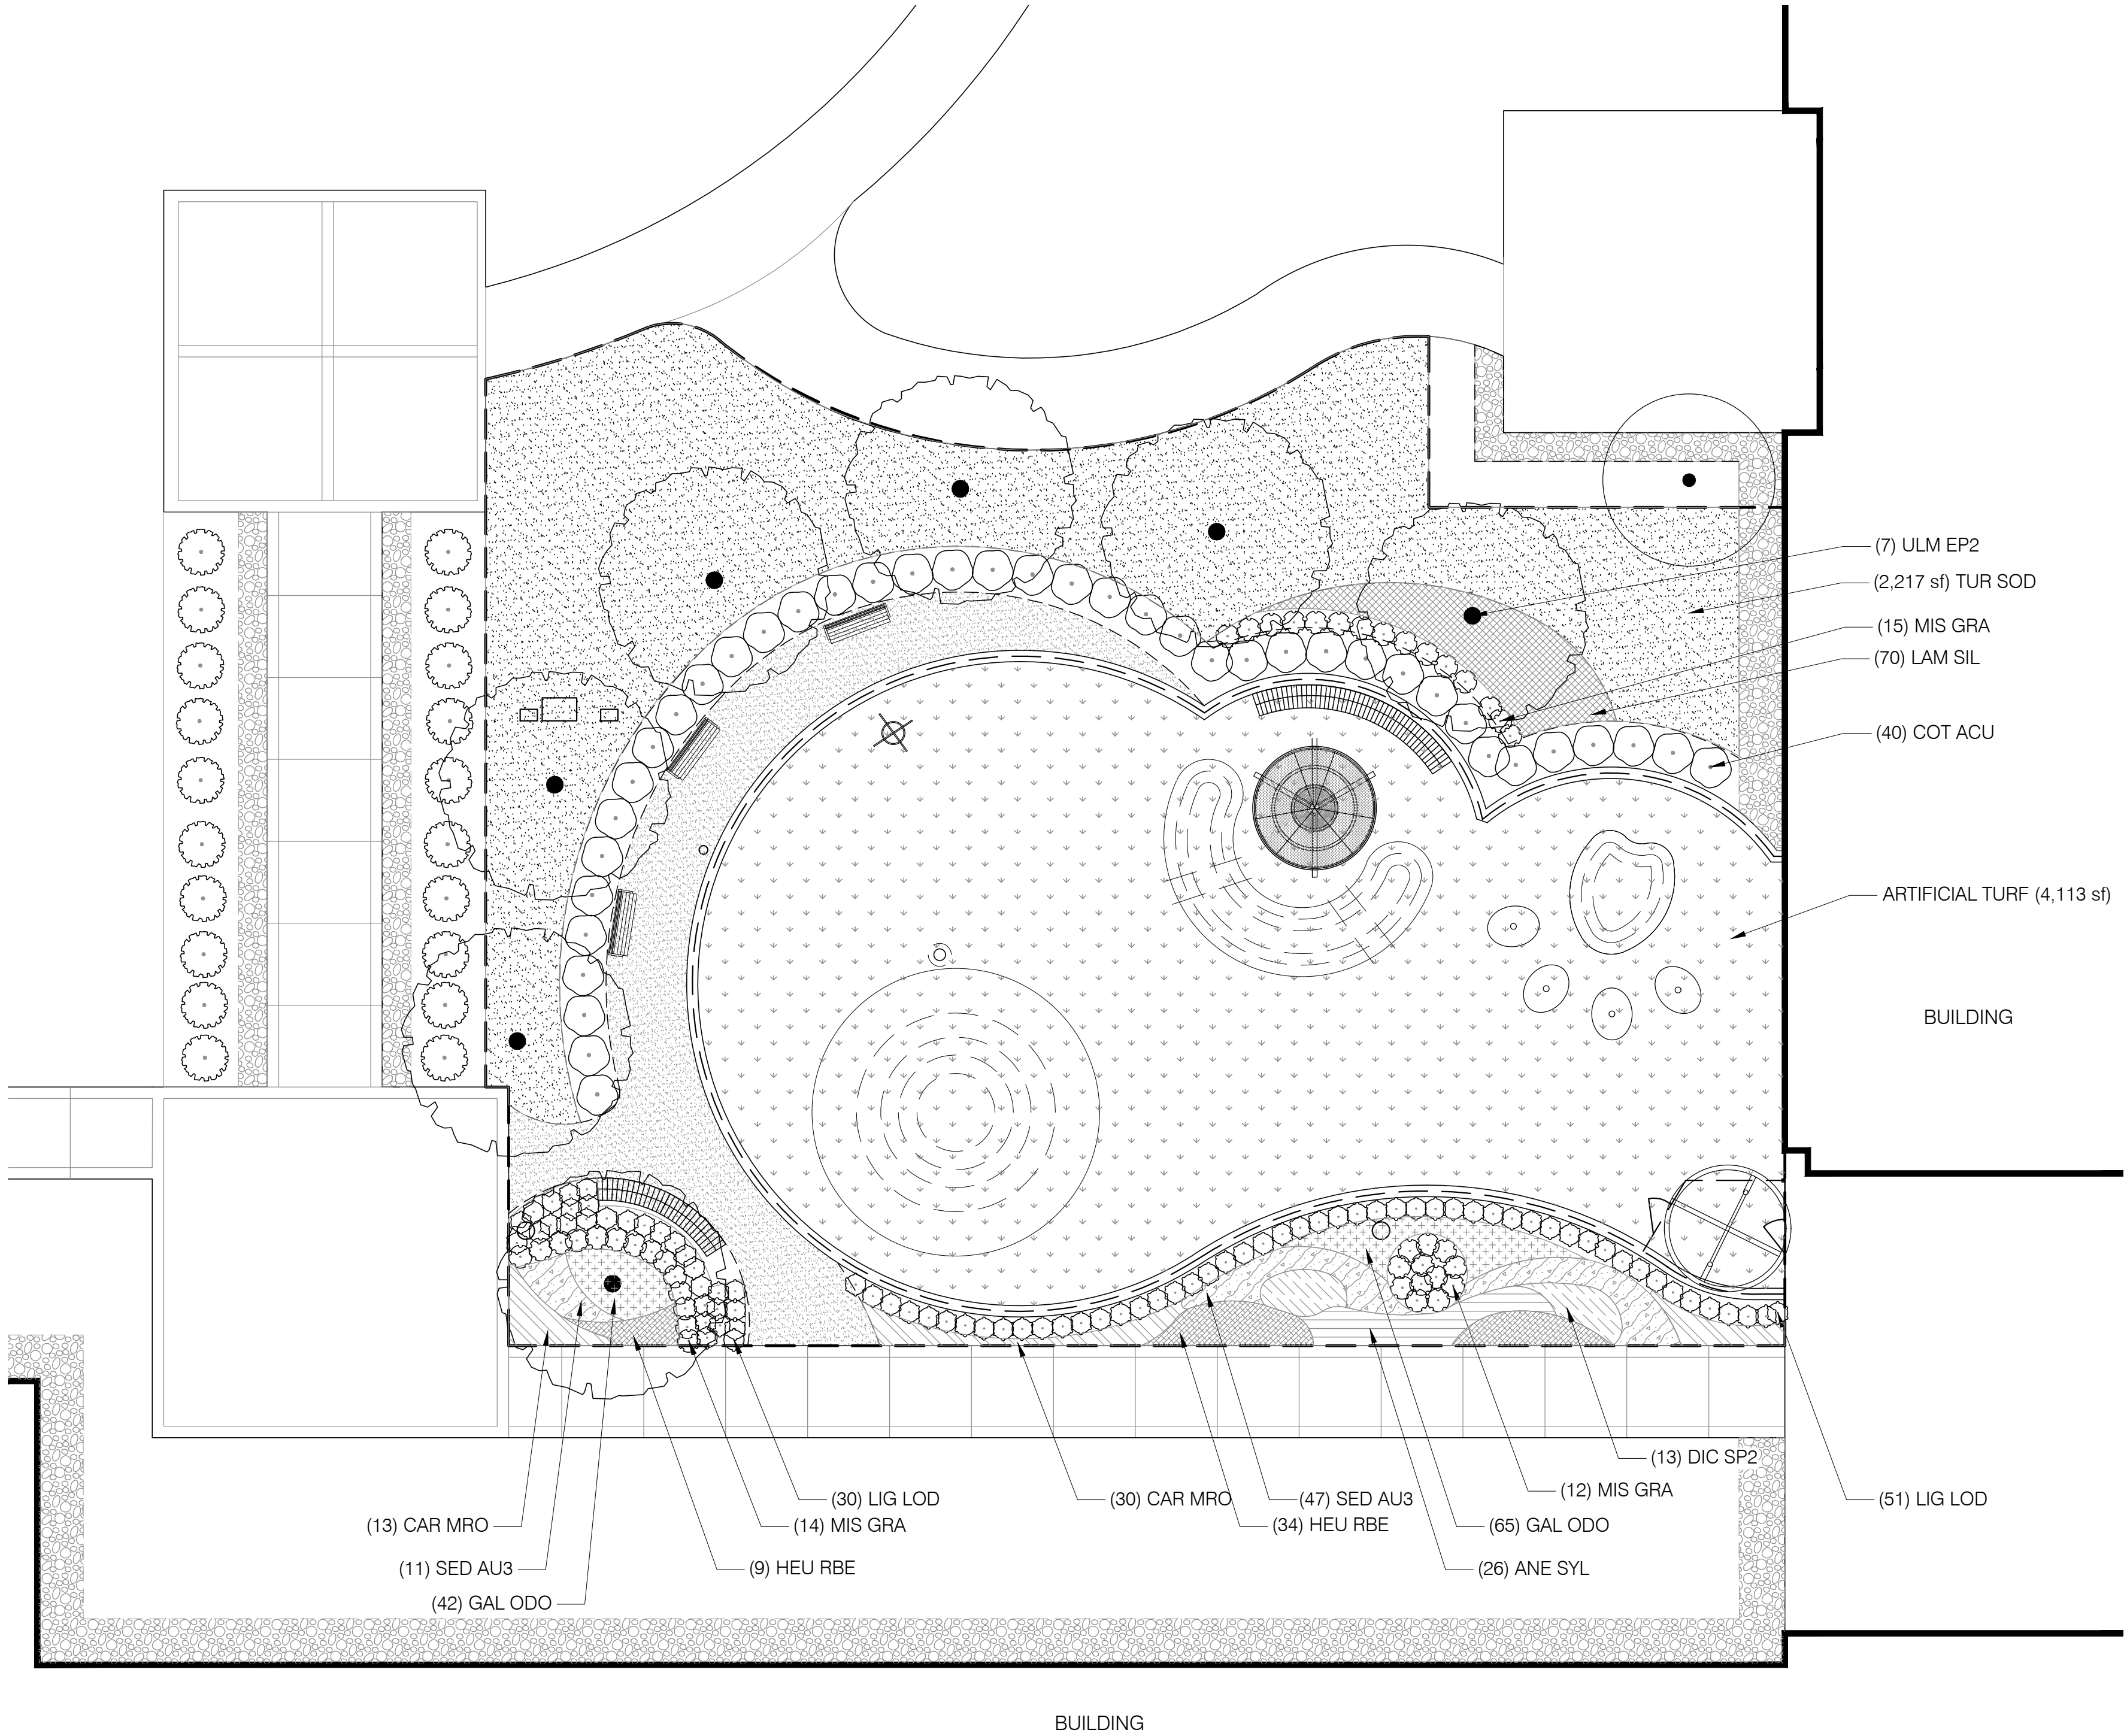
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





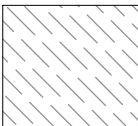
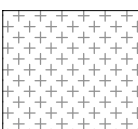
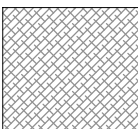
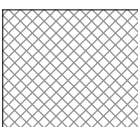
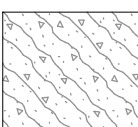
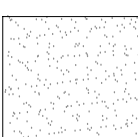
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SITE DETAILS


SHEET NUMBER

LS-503



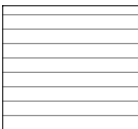

PLANT SCHEDULE					
<div>TREES</div> 	<u>CODE</u>	<u>QTY</u>	<u>BOTANICAL / COMMON NAME</u>	<u>SIZE</u>	
	ULM EP2	7	ULMUS DAVIDIANA JAPONICA `MORTON` TM ACCOLADE ELM	3" CAL	
	<u>CODE</u>	<u>QTY</u>	<u>BOTANICAL / COMMON NAME</u>	<u>SIZE</u>	
	COT ACU	40	COTONEASTER ACUTIFOLIUS PEKING COTONEASTER	7 GAL	
		LIG LOD	81	LIGUSTRUM VULGARE `LODENSE` LODENSE PRIVET	2 GAL
	MIS GRA	41	MISCANTHUS SINENSIS `GRACILLIMUS` MAIDEN GRASS	5 GAL	
<u>GROUND COVERS</u>	<u>CODE</u>	<u>QTY</u>	<u>BOTANICAL / COMMON NAME</u>	<u>SIZE</u>	<u>SPACING</u>
		4,113 SF	ARTIFICIAL TURF		
	ANE SYL	26	ANEMONE SYLVESTRIS SNOWDROP ANEMONE	1 GAL	18" o.c.
	CAR MRO	43	CAREX MORROWII JAPANESE SEDGE	1 GAL	18" o.c.
	DIC SP2	13	DICENTRA SPECTABILIS BLEEDING HEART	1 GAL	24" o.c.
	GAL ODO	107	GALIUM ODORATUM SWEET WOODRUFF	FLATS	12" o.c.
	HEU RBE	43	HEUCHERA X `ROOT BEER` ROOT BEER CORAL BELLS	1 GAL	18" o.c.
	LAM SIL	69	LAMIUM MACULATUM `BEACON SILVER` BEACON SILVER LAMIUM	1 GAL	18" o.c.
	SED AU3	58	SEDUM X `AUTUMN JOY` AUTUMN JOY SEDUM	1 GAL	18" o.c.
	TUR SOD	2,223 SF	TURF SOD DROUGHT TOLERANT FESCUE BLEND	SOD	

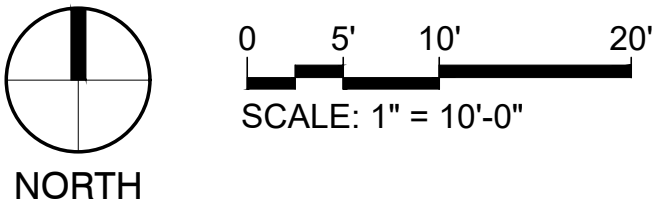

CHILDREN'S HOSPITAL COLORADO

# CANINE RESPITE AREA

REVISIONS:

No.	DATE	DESCRIPTION	BY
	11-03-20	DD SUBMITTAL	

DESIGNED BY:  
DRAWN BY:  
CHECKED BY:

SEAL:

SCALE:  
1" = 10'

DATE ISSUED:  
10/14/2020

SHEET TITLE  
PLANTING PLAN

SHEET NUMBER

LP-101



TREES



Accolade Elm  
*Ulmus davidiana japonica 'Morton' TM*

SHRUBS



Peking Cotoneaster  
*Cotoneaster acutifolius*



Lodense Privet  
*Legustrum vulgare 'Lodense'*



Maiden Grass  
*Miscanthus sinensis 'gracillimus'*

PERENNIALS



Snowdrop Anemone  
*Anemone sylvestris*



Japanese Sedge  
*Carex morrowii*



Bleeding Heart  
*Dicentra spectabilis*



Root Beer Coral Bells  
*Huechera x 'Root Beer'*



Autumn Joy Sedum  
*Sedum x 'Autumn Joy'*

GROUND COVERS



Beacon Silver Lamium  
*Lamium maculatum 'Beacon Silver'*



Sweet Woodruff  
*Galium odoratum*

CHILDREN'S HOSPITAL COLORADO  
**CANINE RESPITE AREA**

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SEAL:

SCALE:



DATE ISSUED:  
10/14/2020

SHEET TITLE  
PLANT PALETTE



SHEET NUMBER

LP-102



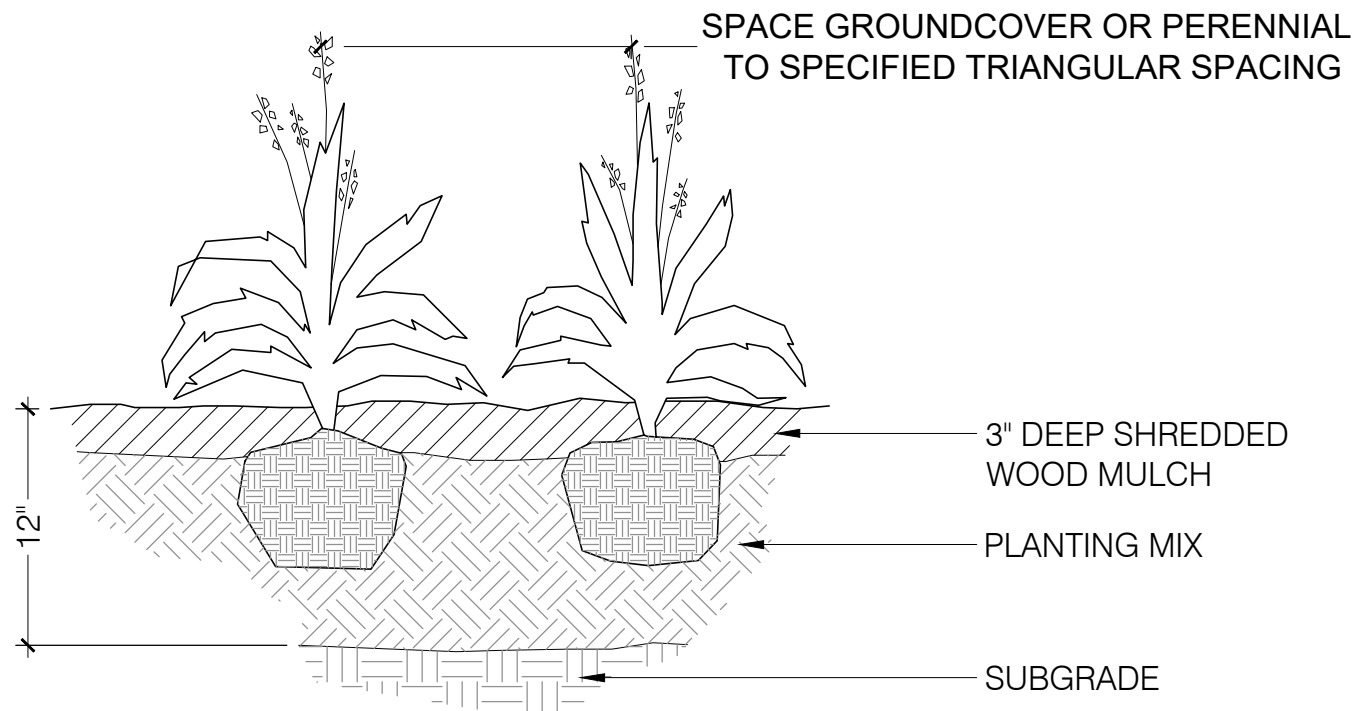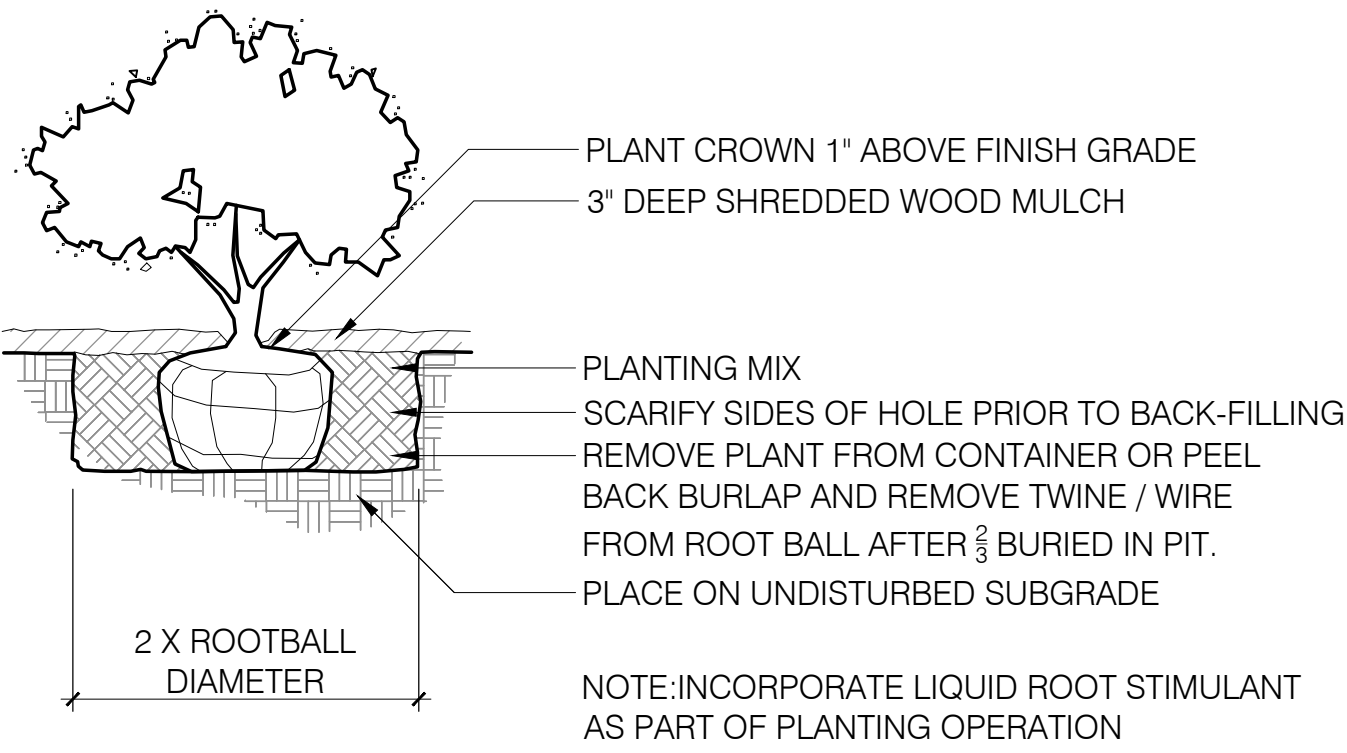

P TRIANGULAR	R ROW	AREA PER PLANT SQ.FT.
4"	3 7/16"	.096
6"	5 1/4"	.22
8"	7"	.385
10"	8 3/4"	.60
12"	10 3/8"	.87
18"	1'-3 5/8"	1.95
24"	1'-8 3/4"	3.46
30"	2'-2"	5.42
3"	2'-7"	7.80
4"	3'-5 1/2"	13.84
5"	4'-4"	21.65
6"	5'-2 3/8"	31.20

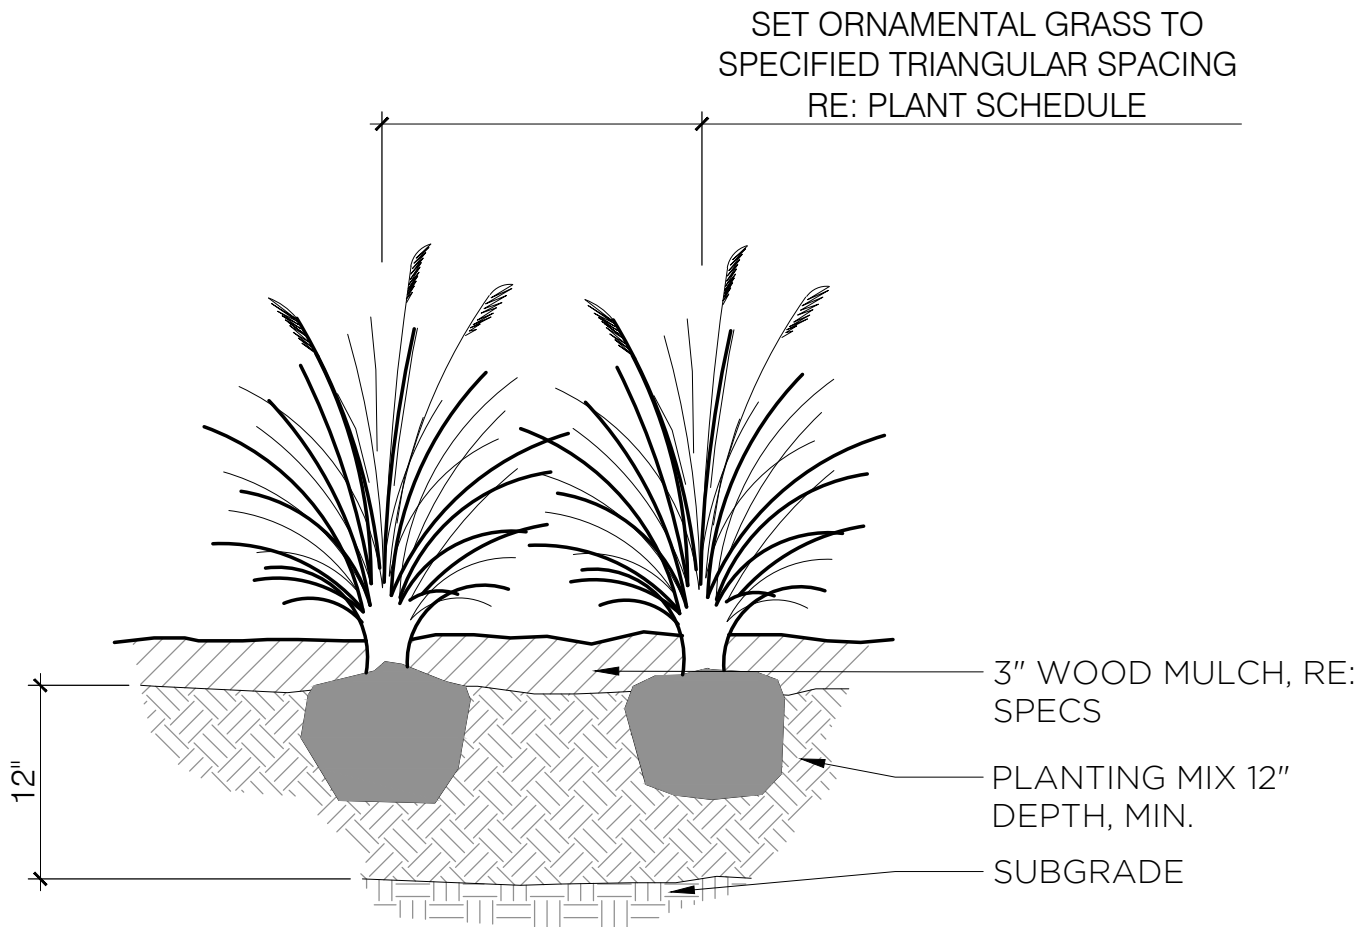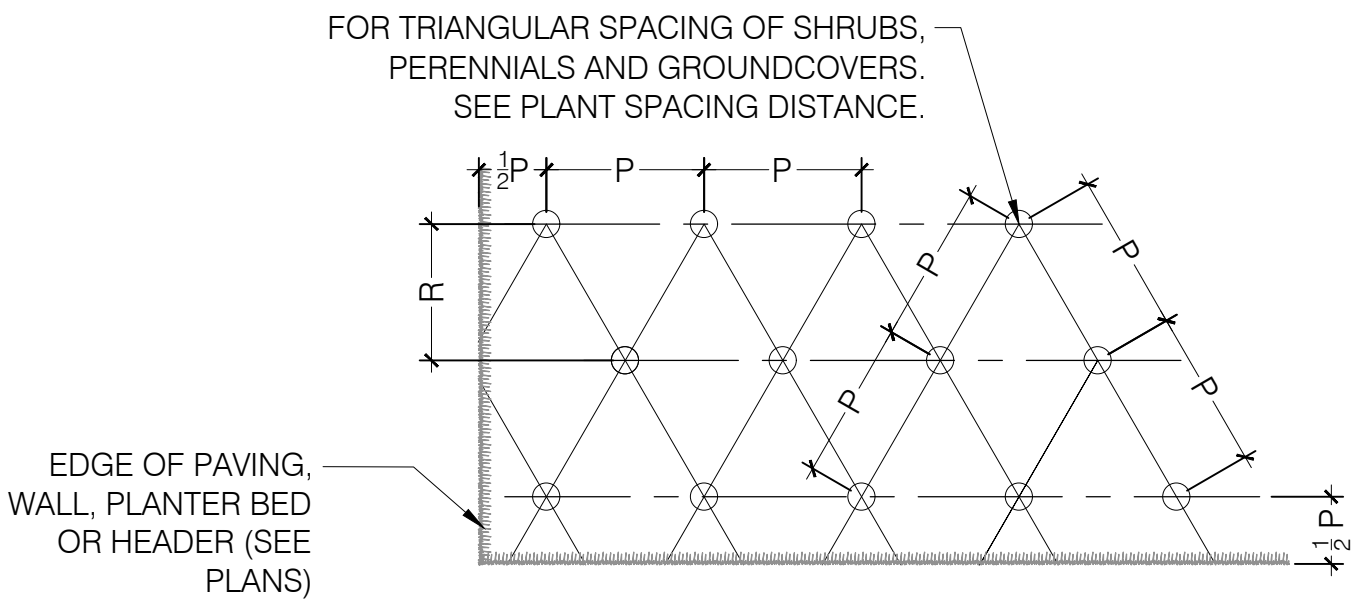

## 1 SHRUB PLANTING

1/2" = 1'-0"

## 2 GROUNDCOVER AND PERENNIAL PLANTING

1" = 1'-0"


## 3 SHRUB AND PERENNIAL SPACING

3/8" = 1'-0"

## 4 ORNAMENTAL GRASS PLANTING

1" = 1'-0"


P-DOG-21

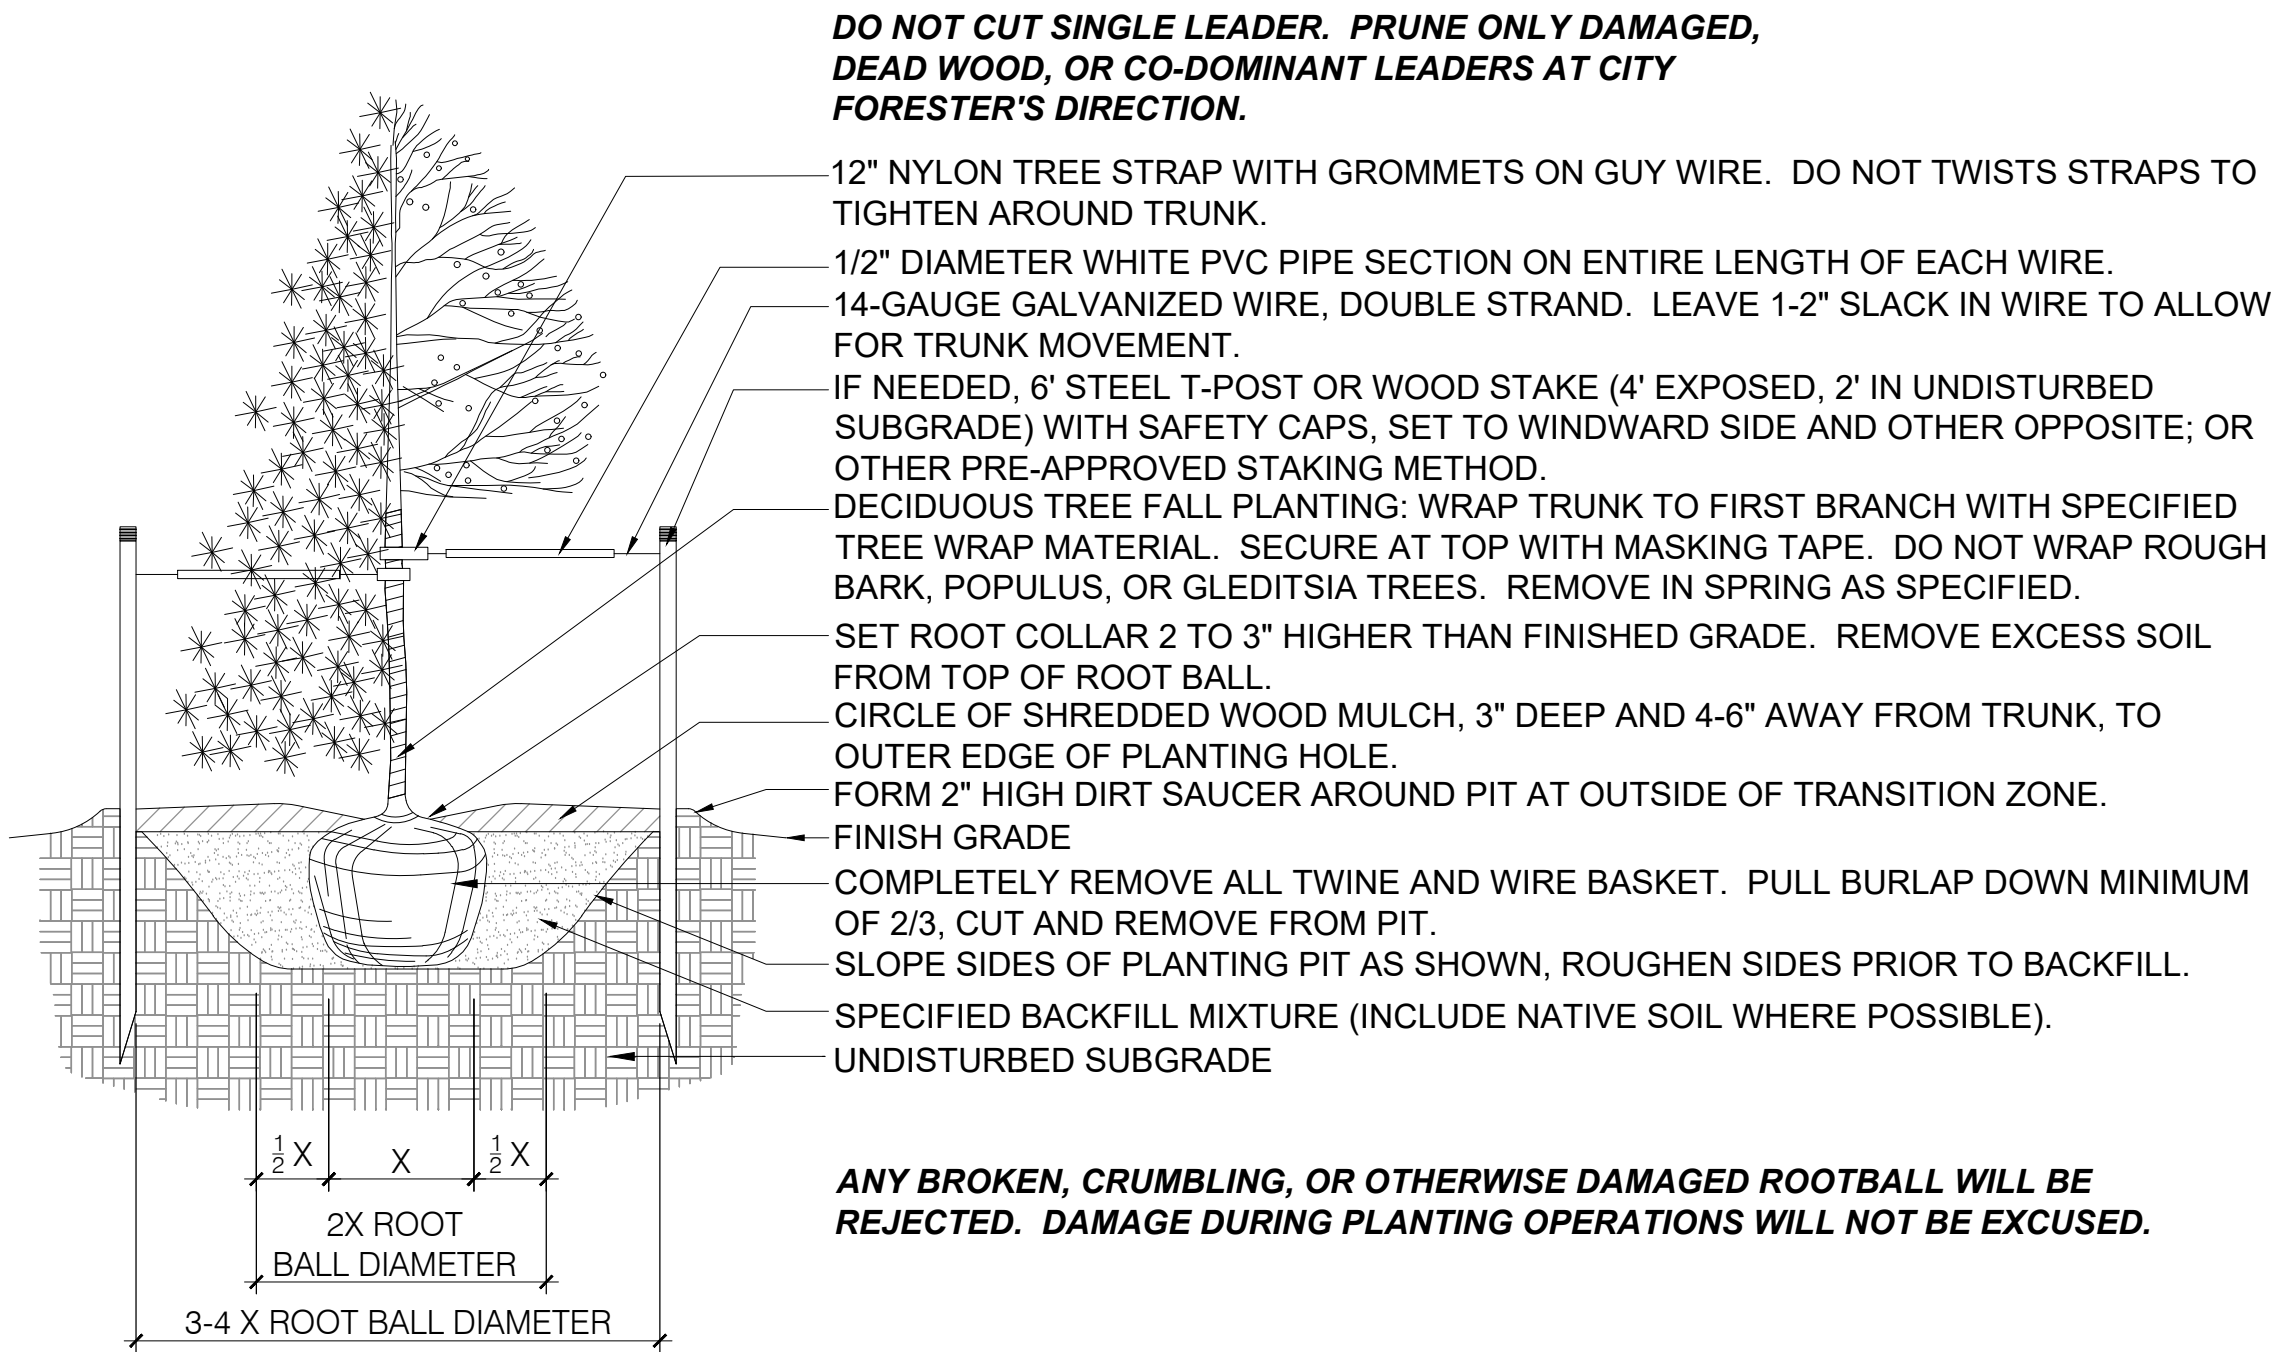

**ANY BROKEN, CRUMBLING, OR OTHERWISE DAMAGED ROOTBALL WILL BE REJECTED. DAMAGE DURING PLANTING OPERATIONS WILL NOT BE EXCUSED.**

## 6 TREE STAKING & GUYING

1/2" = 1'-0"

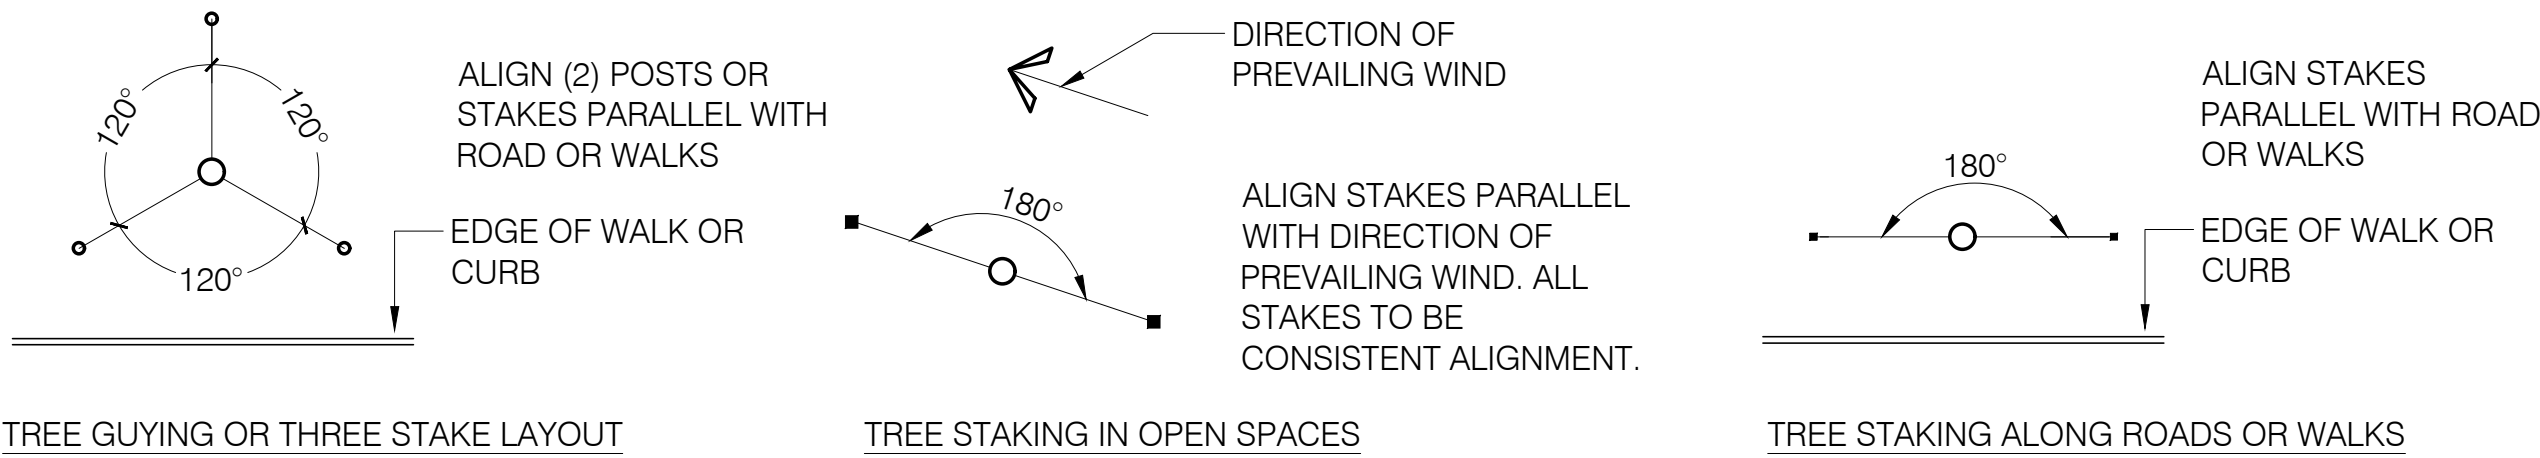

## 5 TREE PLANTING DETAIL

6" = 1'-0"

### REVISIONS:

No.	DATE	DESCRIPTION	BY
	11-03-20	DD SUBMITTAL	

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SCALE:

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10/14/2020

SHEET TITLE  
PLANTING DETAILS

SHEET NUMBER

**LP-501**